
SOHI APARMENTS

927 SOUTH 400 WEST SALT LAKE CITY, UTAH 84101 SITE PLAN REVIEW

PROJECT IMAGE



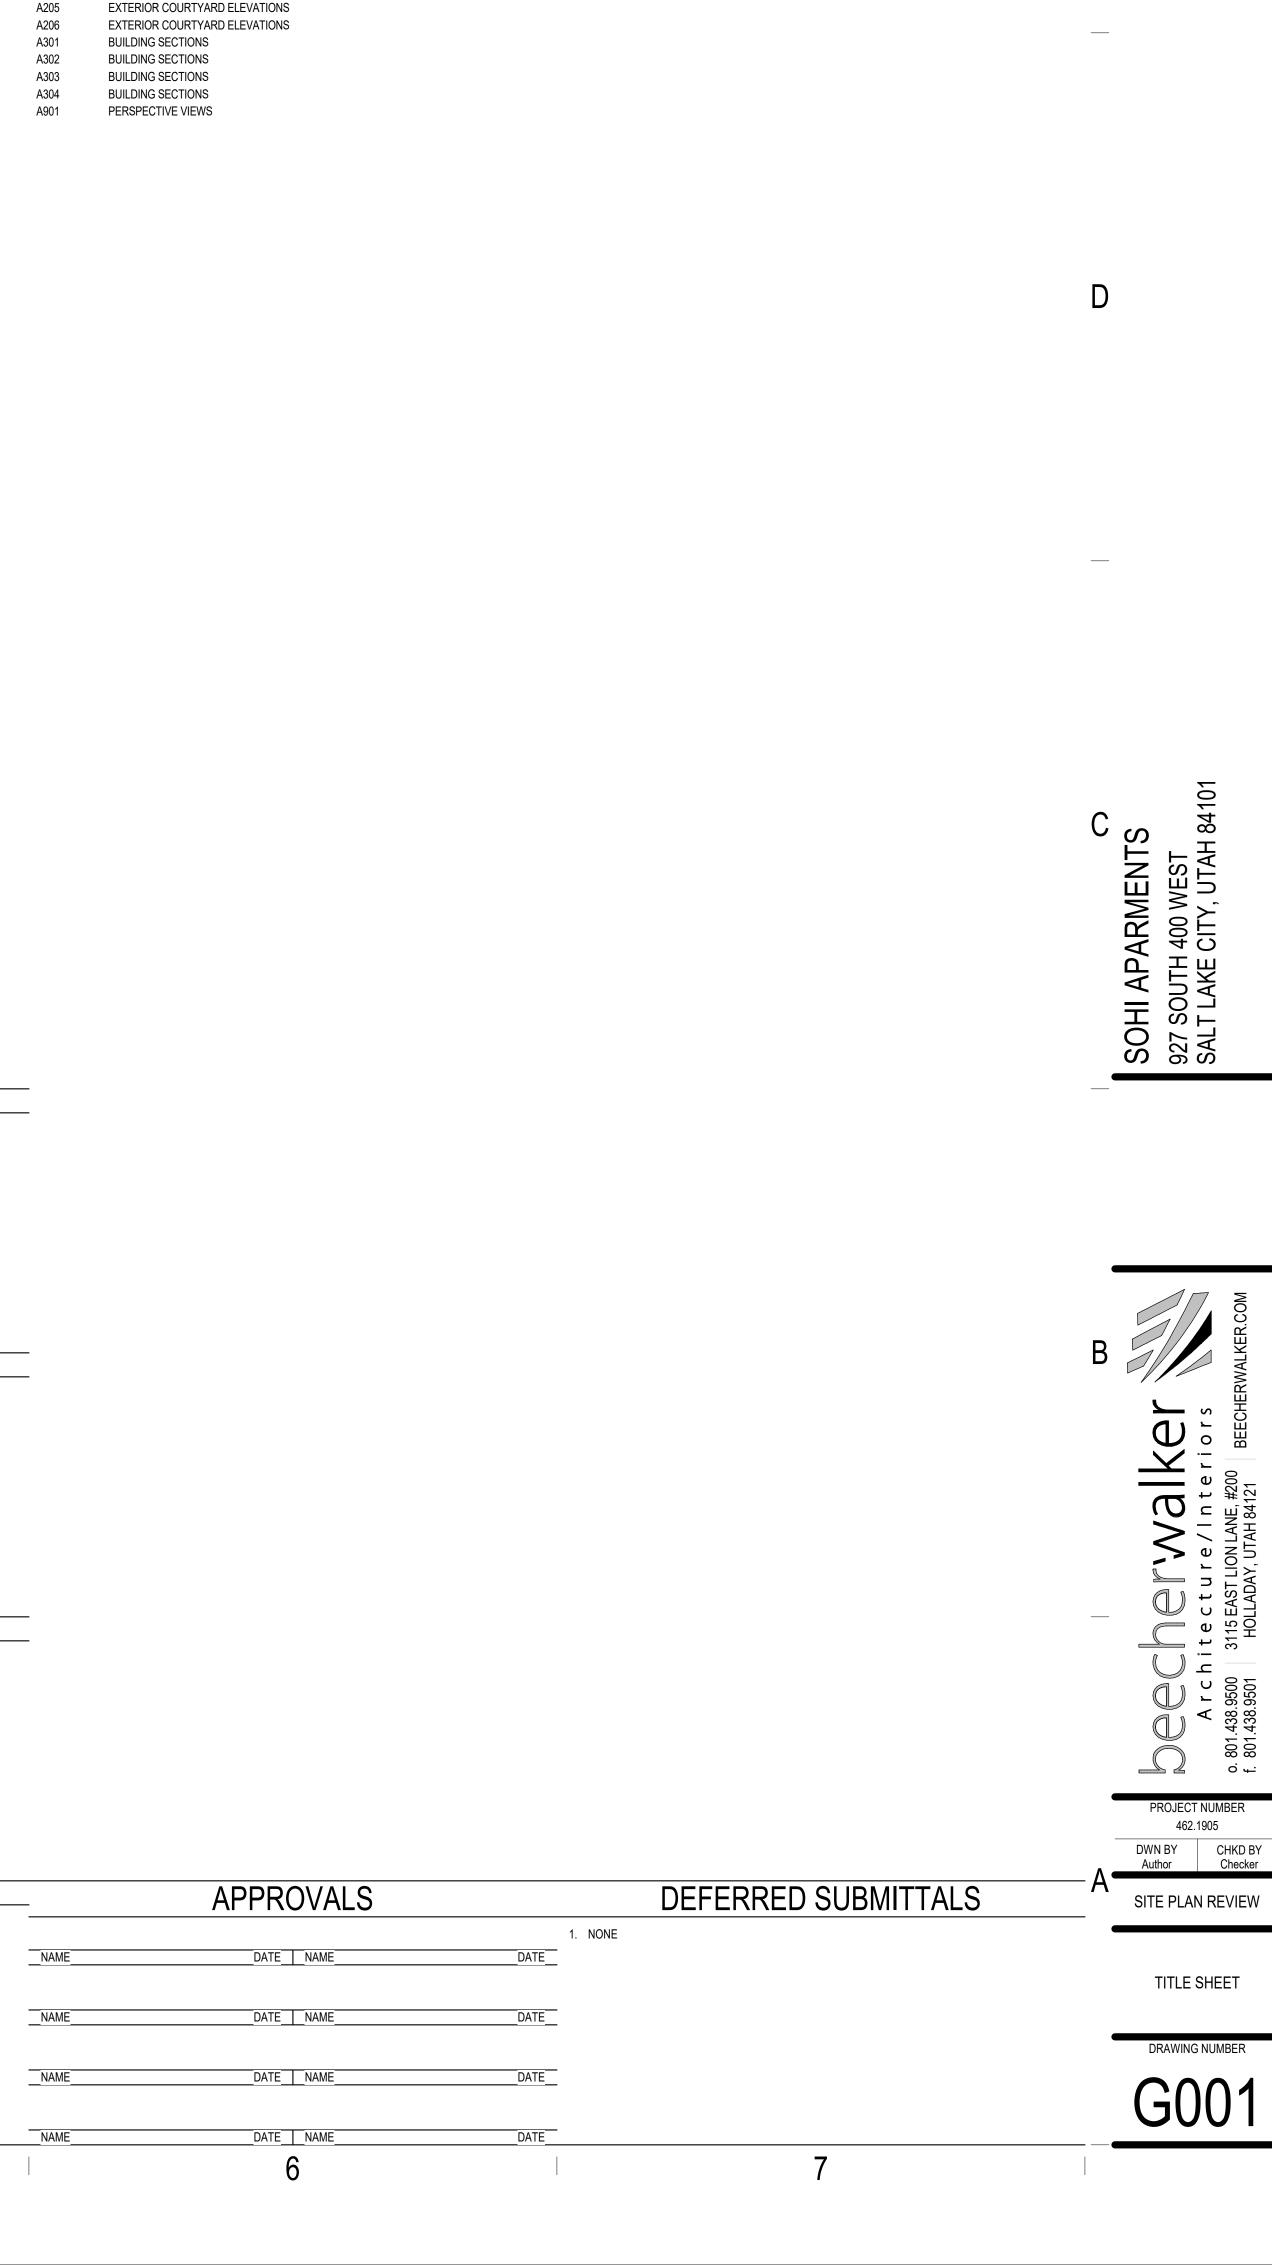

INDEX OF DRAWINGS


SHEET NO. SHEET TITLE

CODE COMPLIANCE AND GENERAL INFORMATION

EXISTING CONDITIONS & DEMO PLAN

LANDSCAPE PLAN

LEVEL PG FLOOR PLAN LEVEL PU FLOOR PLAN SHEET NO. SHEET TITLE

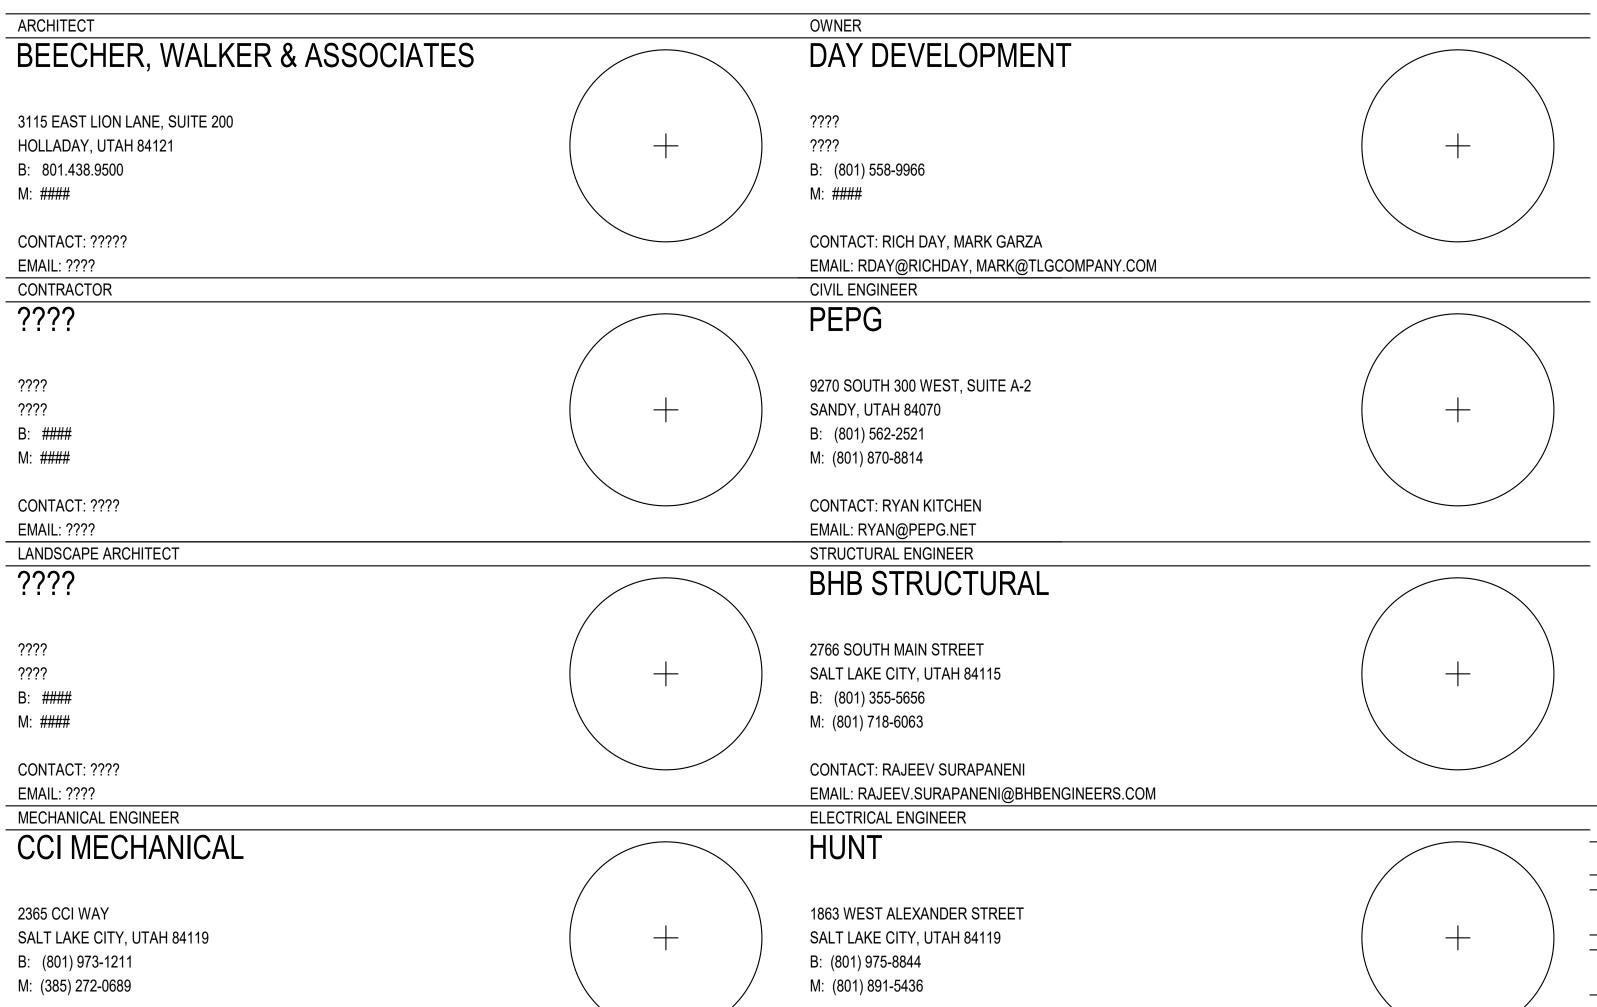


CONTACT: DARRIN SANDERS

EMAIL: DSANDERS@HUNTELECTRIC.COM

CONTACT: ZACH MOUW

EMAIL: ZMOUW@CCIMECHANICAL.COM

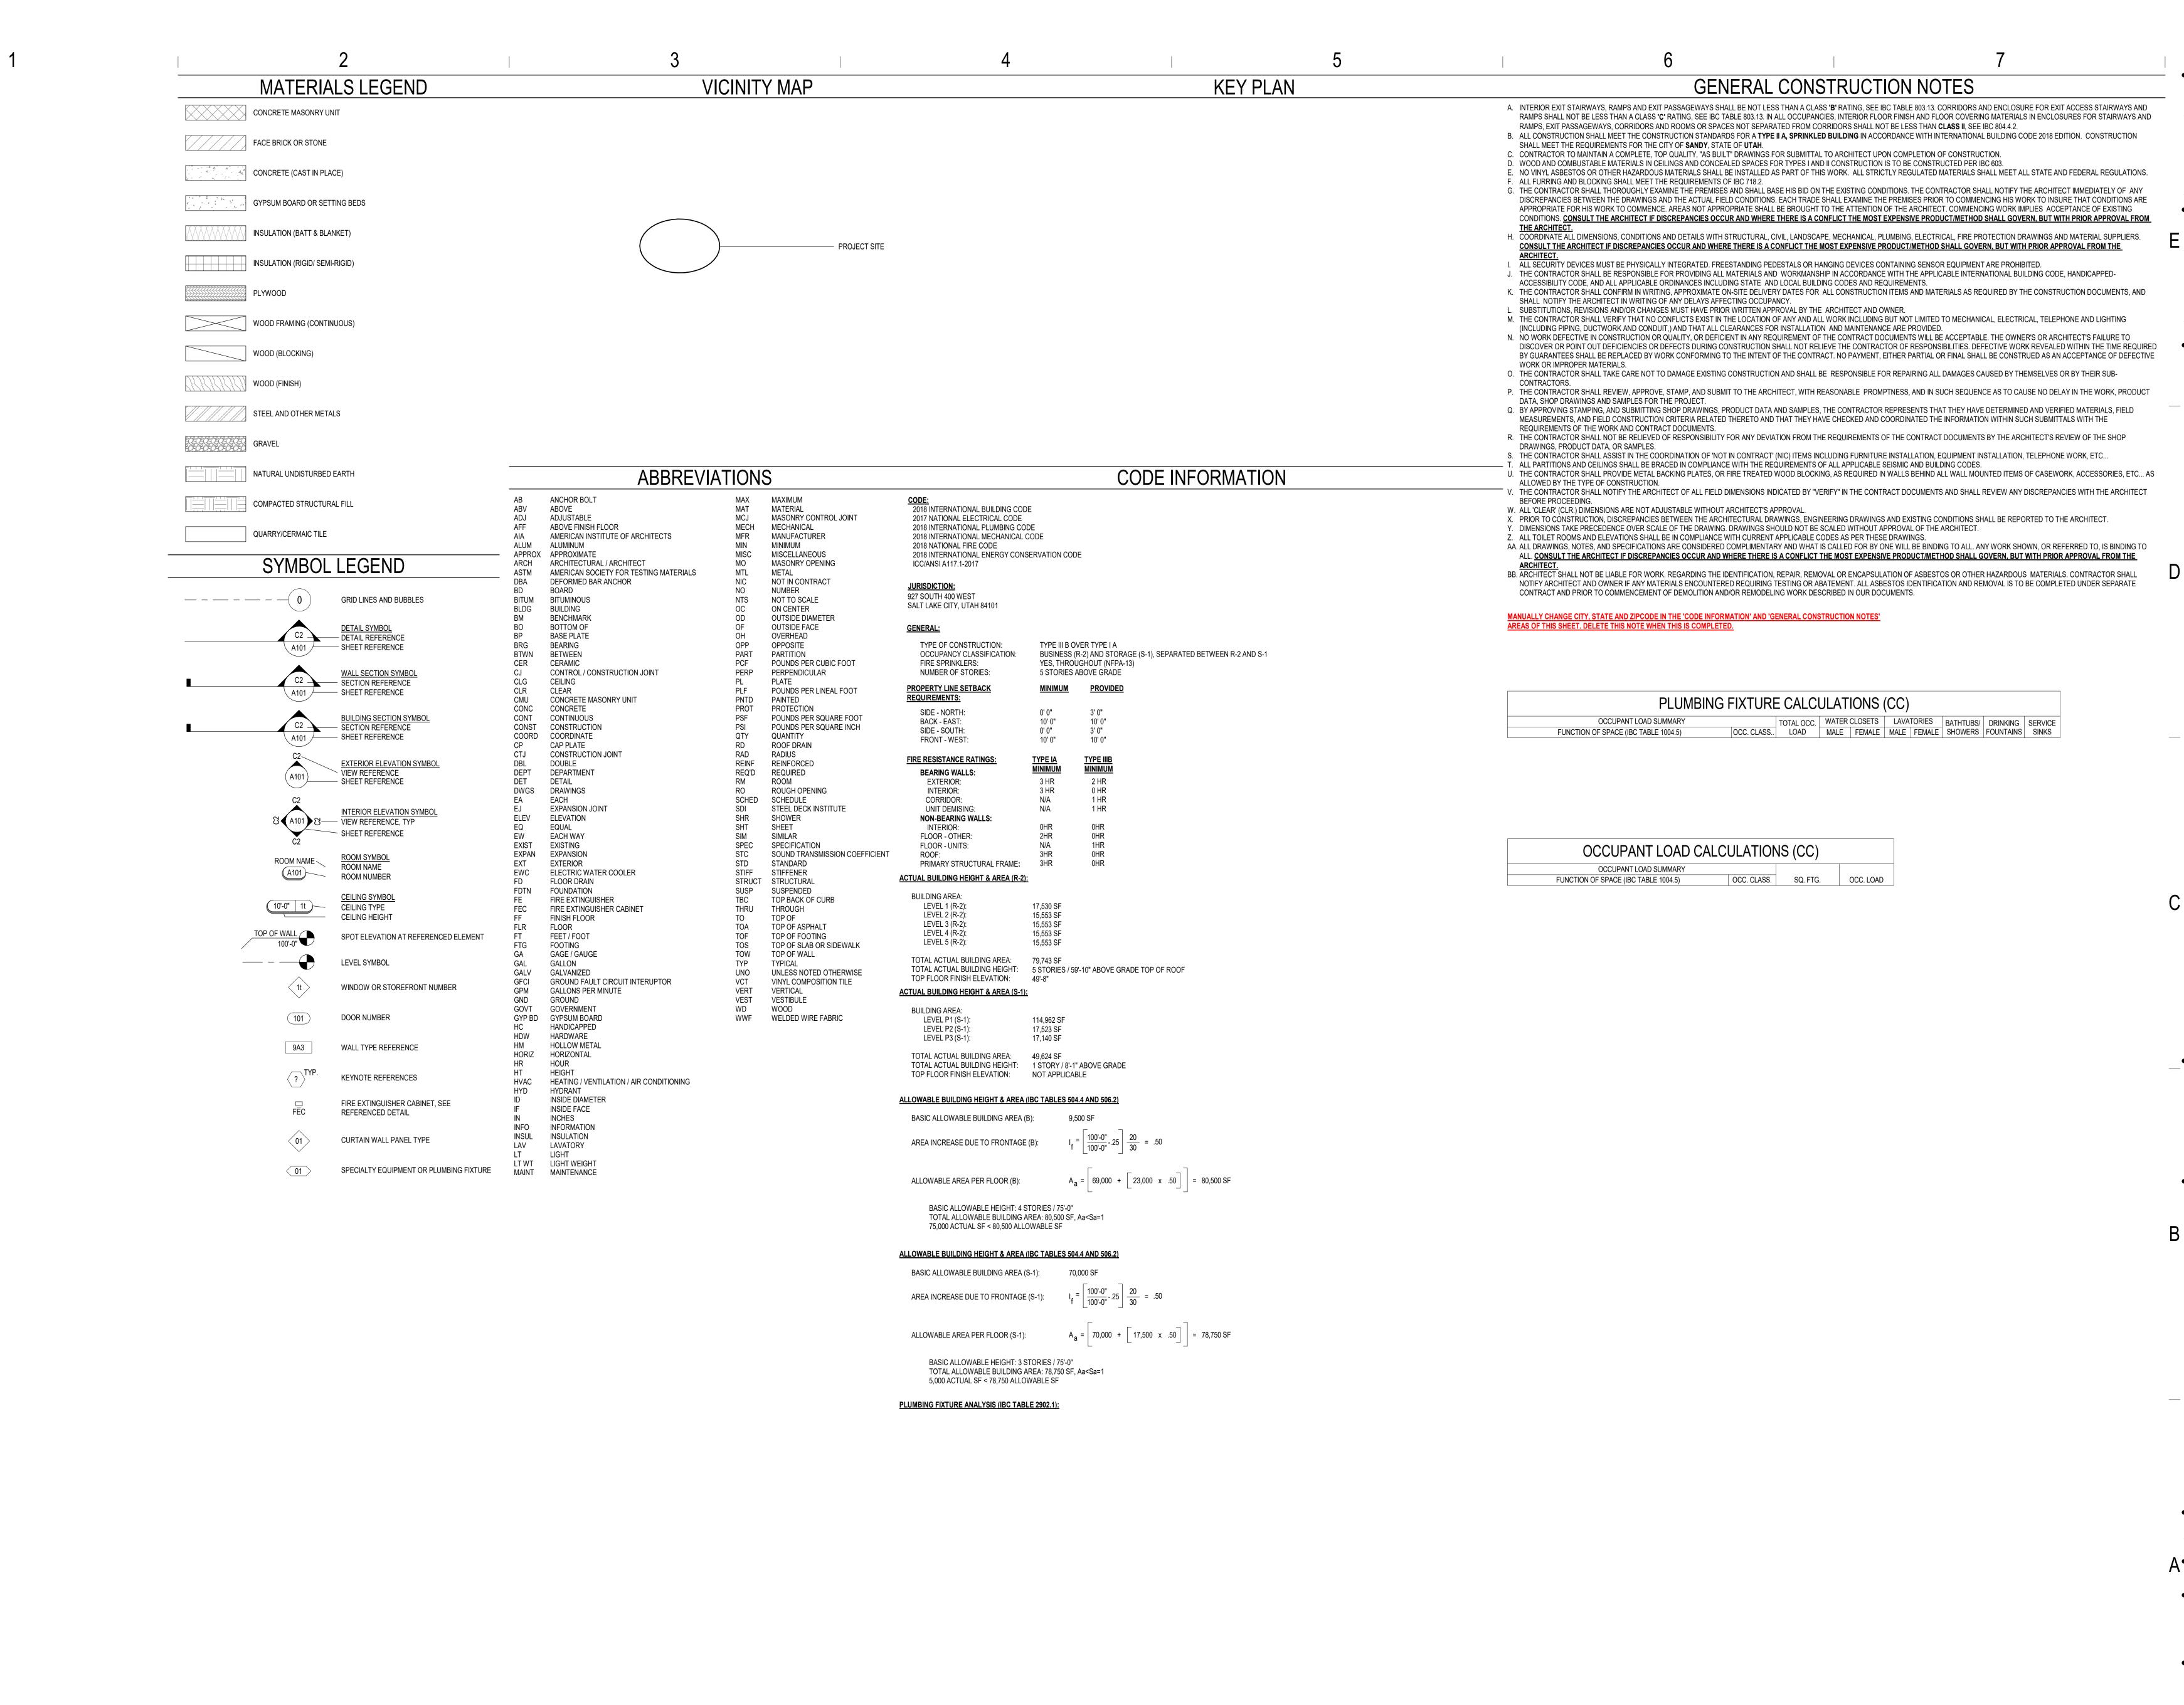



7


A o. 801.438.


CODE COMPLIANCE AND GENERAL INFORMATION

DRAWING NUMBER

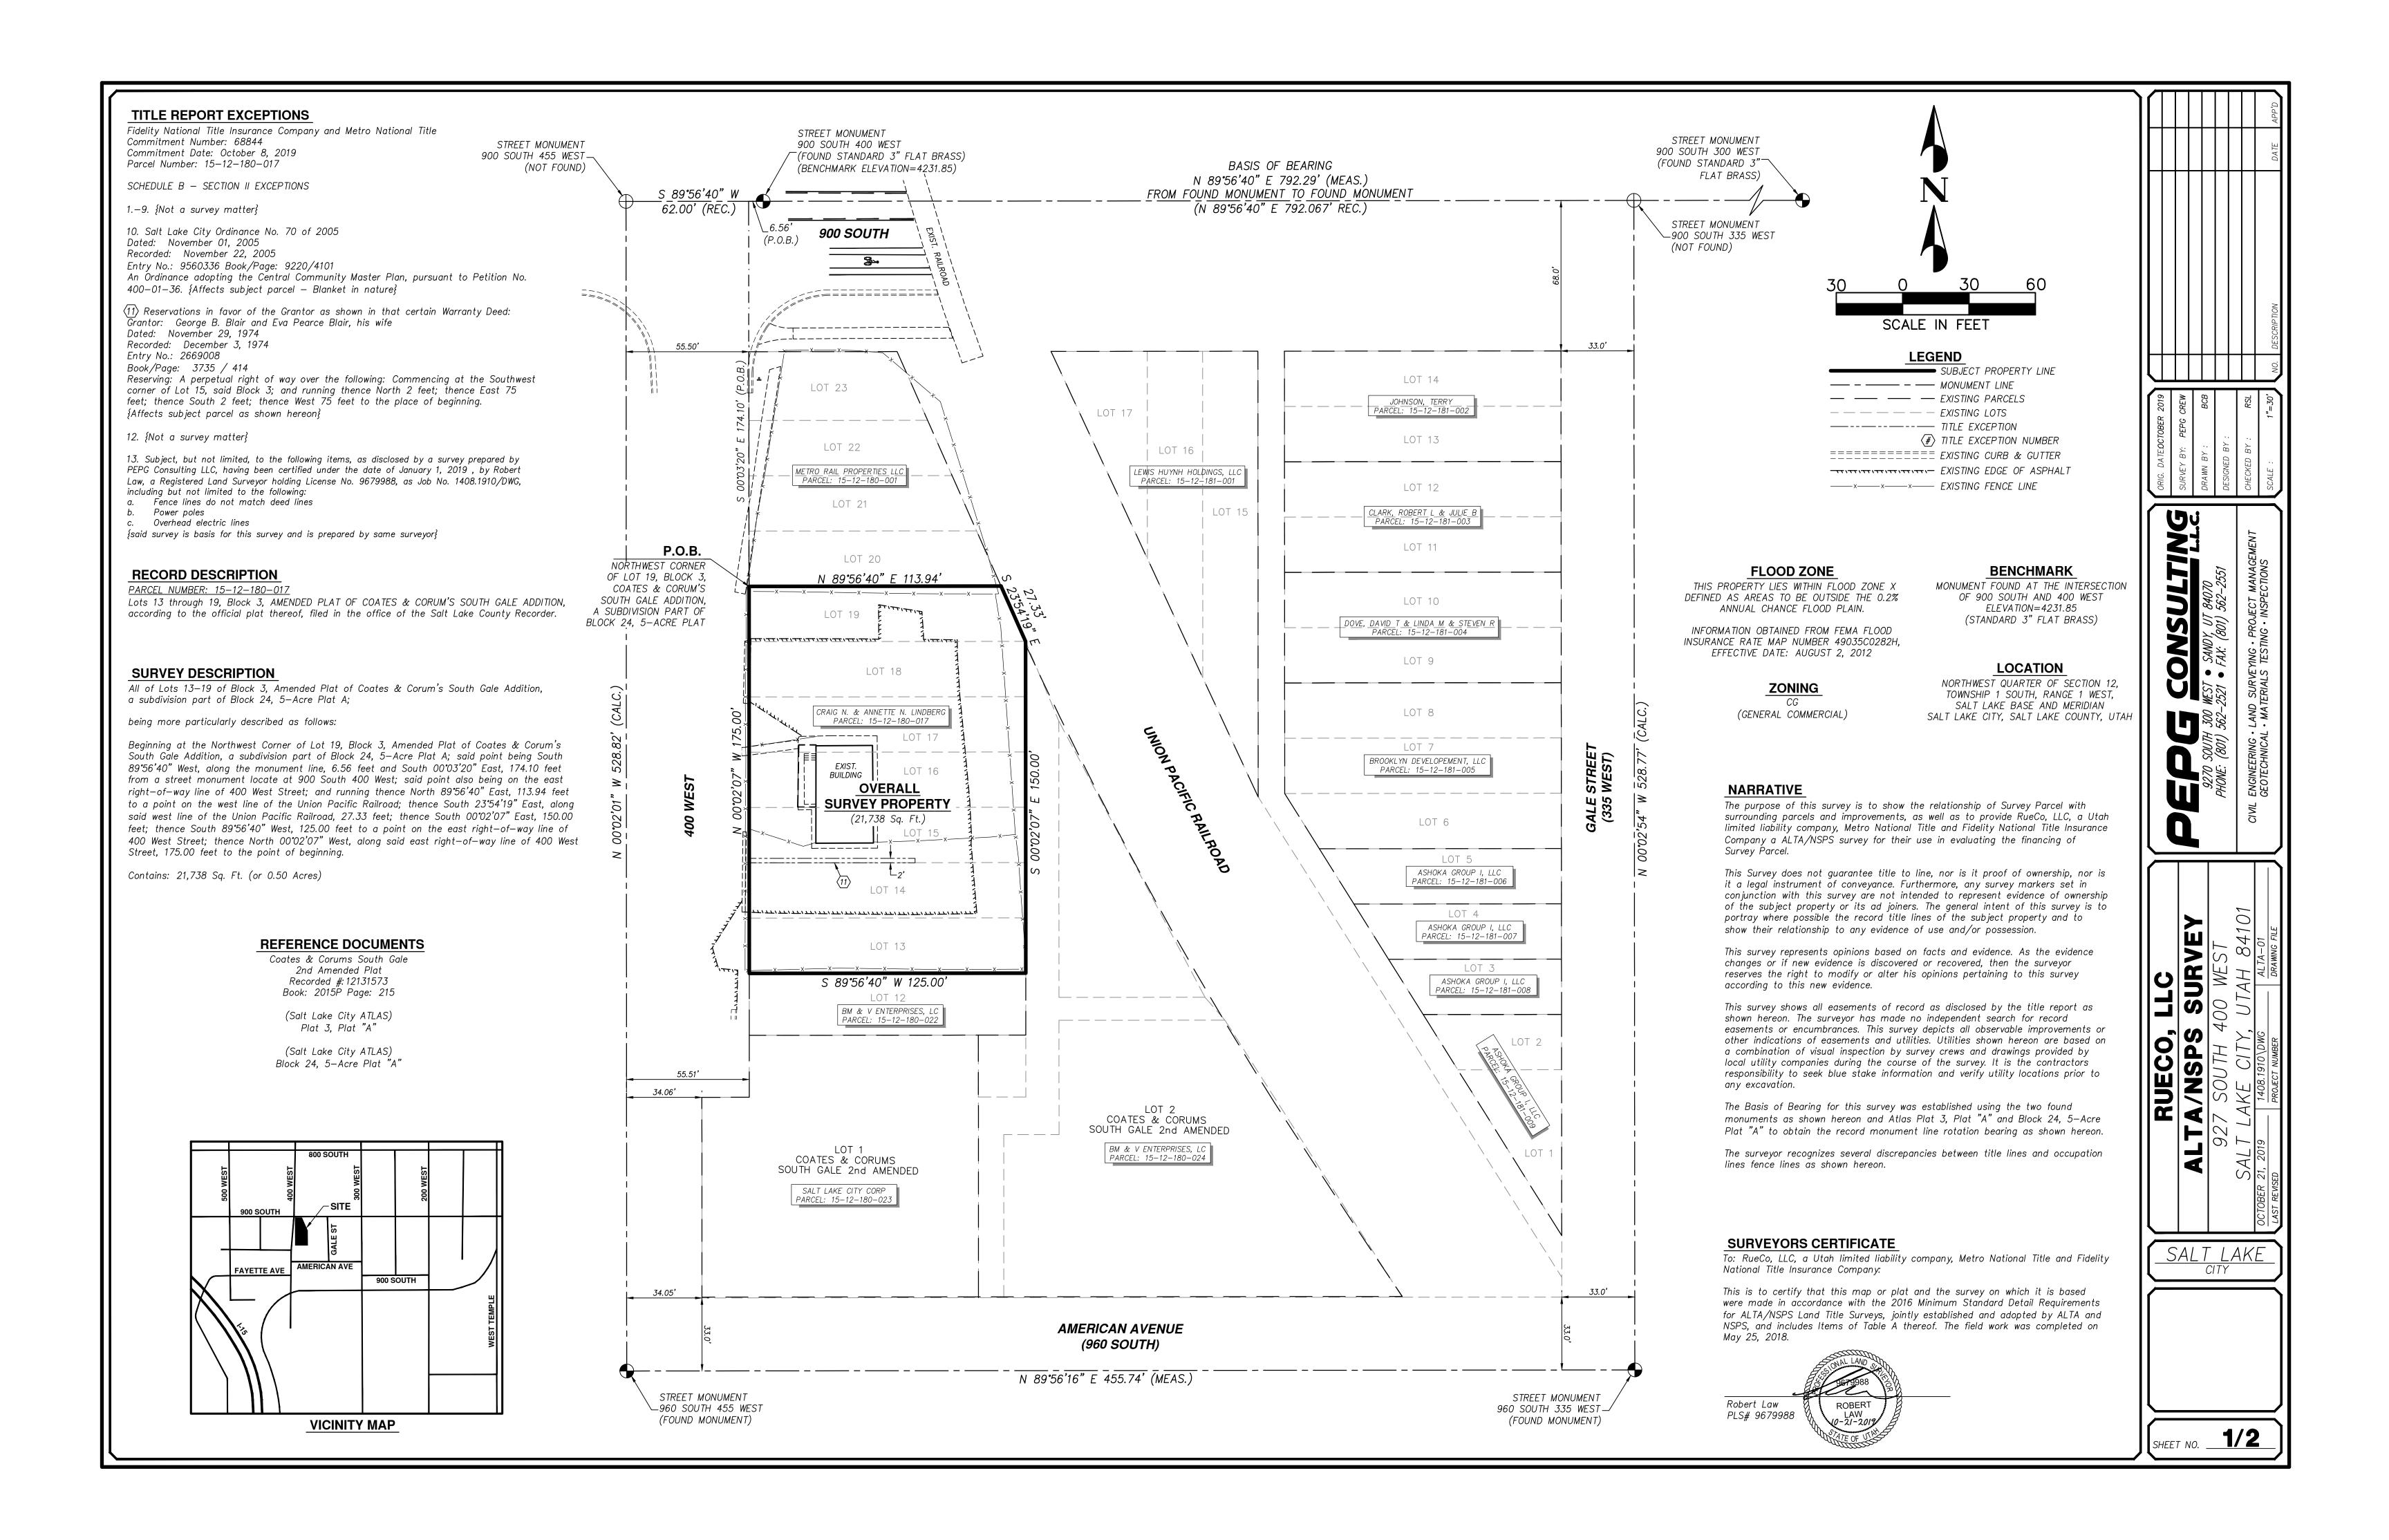

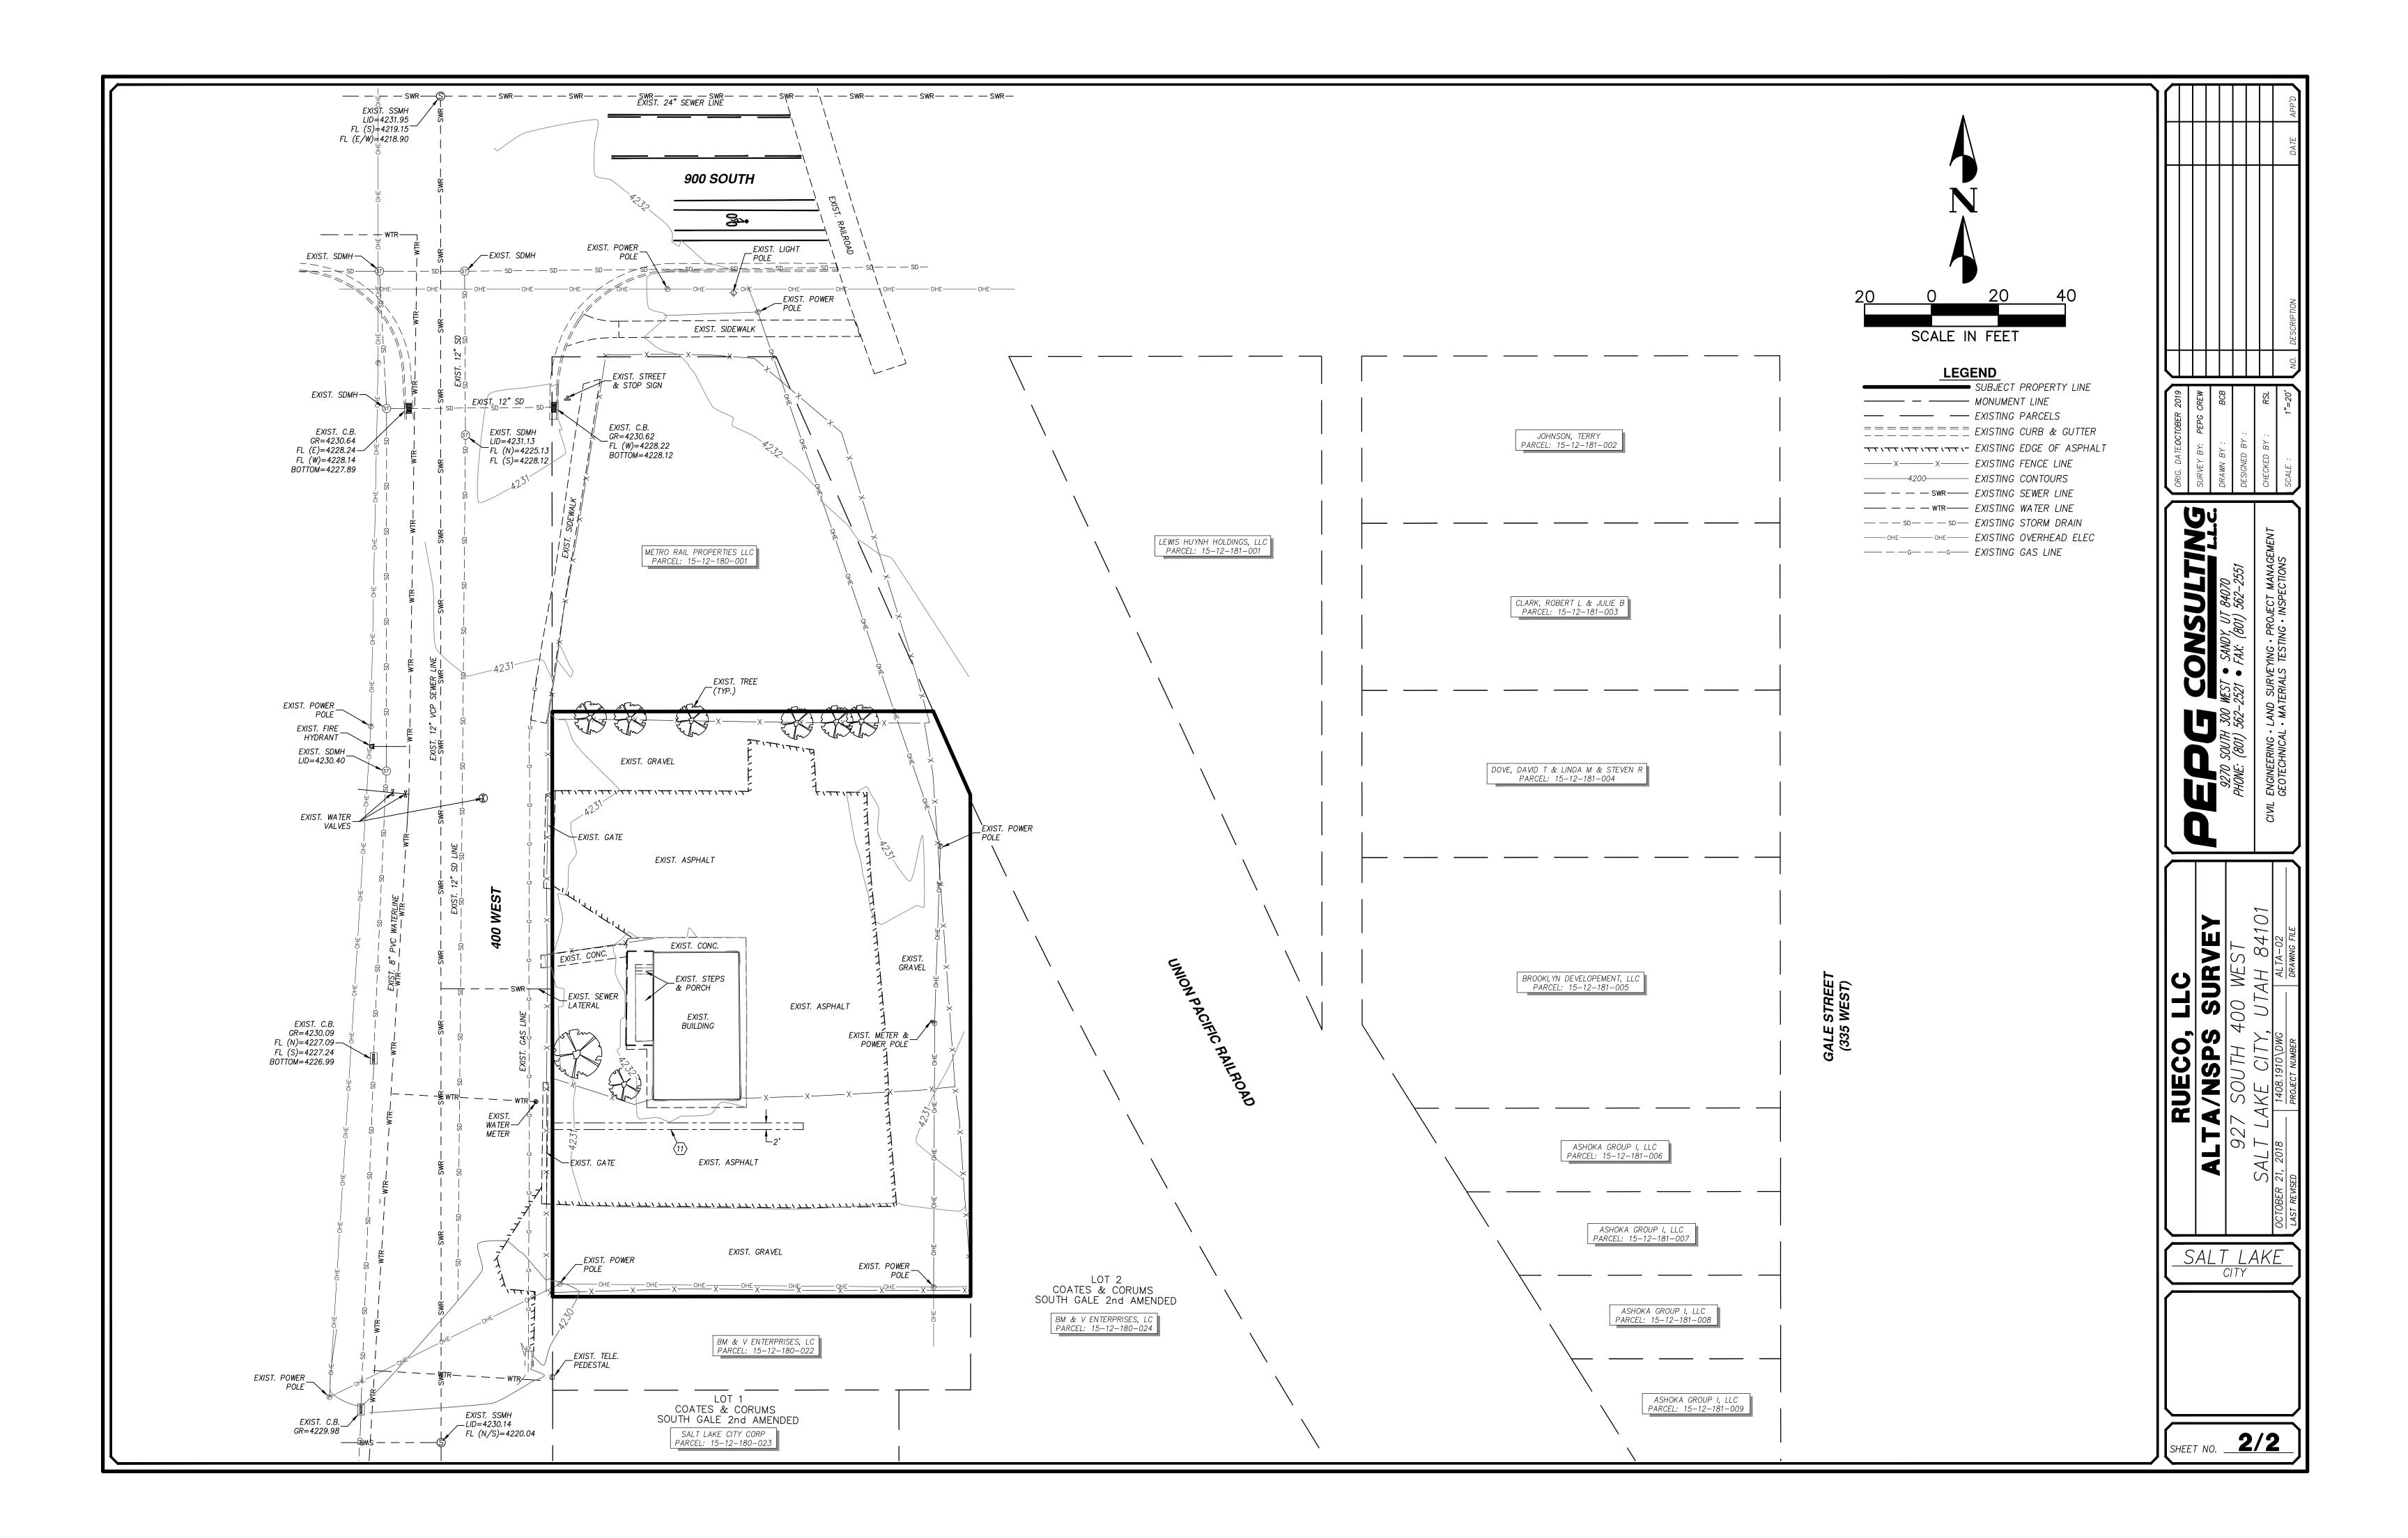

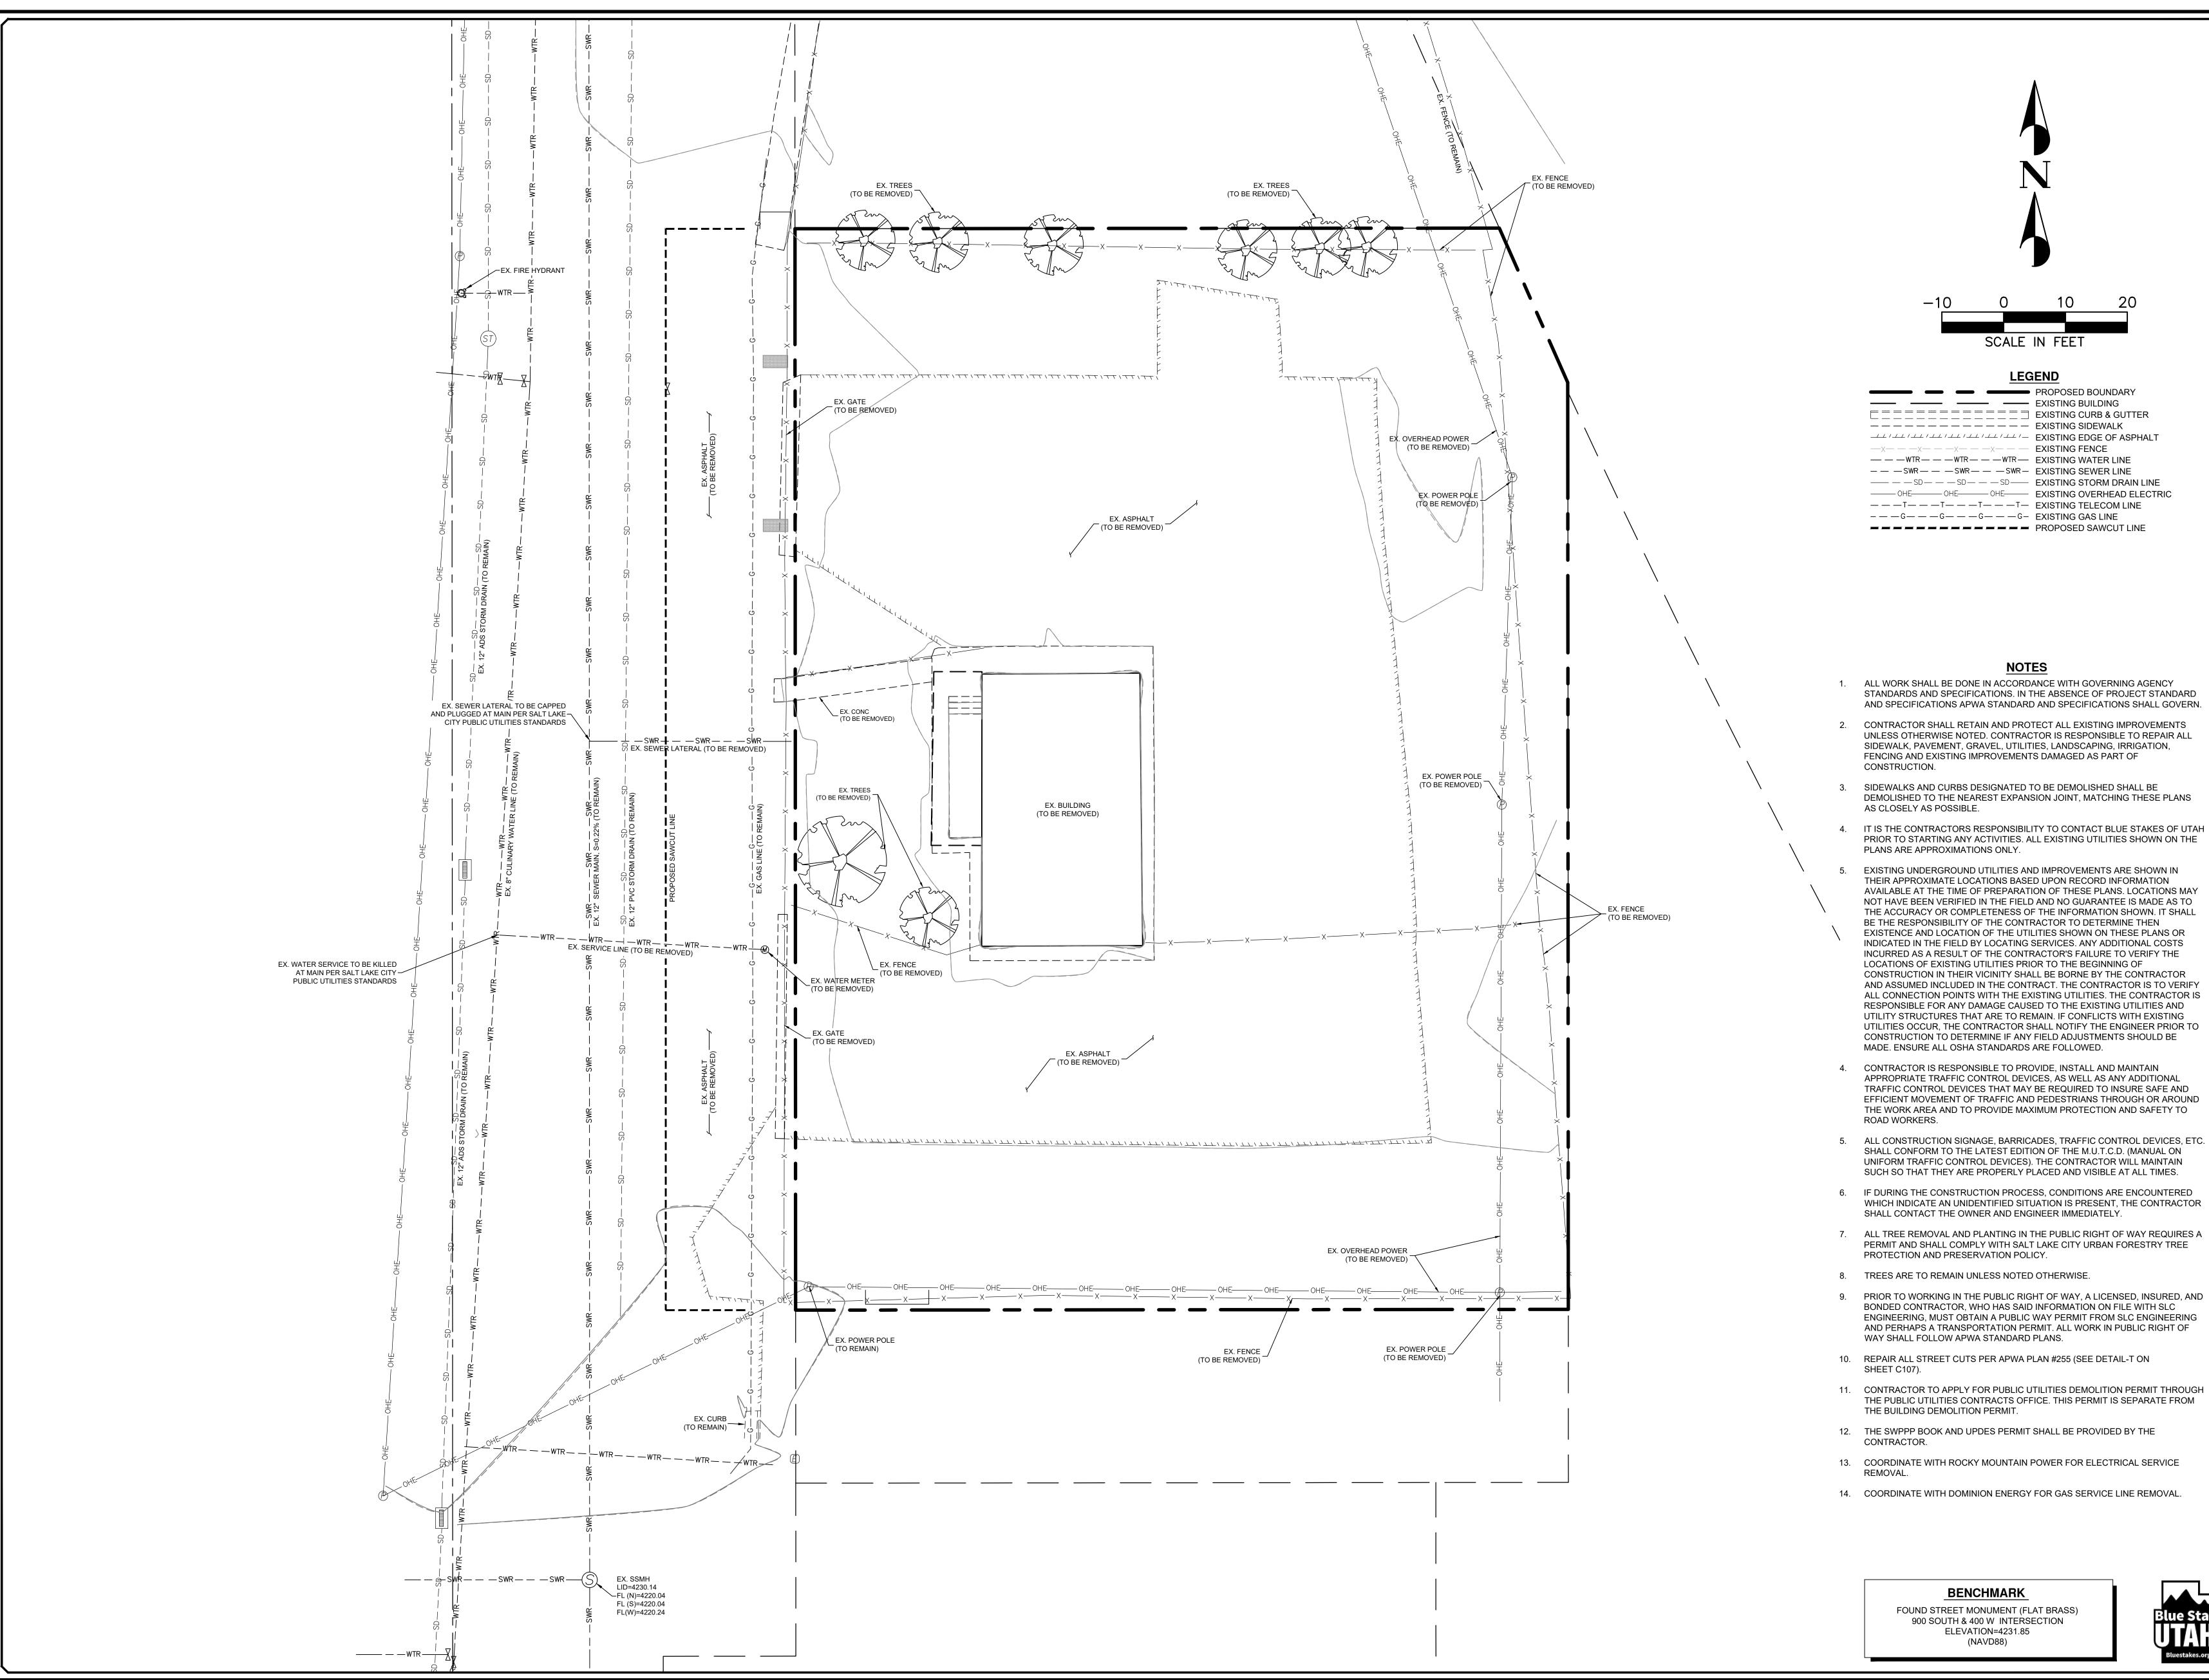

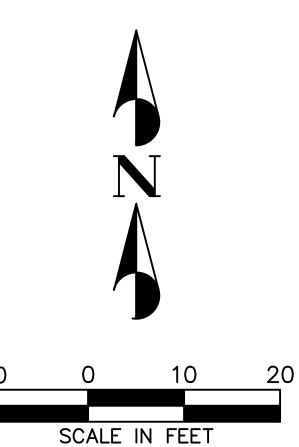

PROPOSED BOUNDARY ---- EXISTING BUILDING ---- EXISTING SIDEWALK -X- -X- -X- -X- -X- EXISTING FENCE

— — — WTR — — WTR — EXISTING WATER LINE -- - SWR-- - SWR-- SWR- EXISTING SEWER LINE OHE—OHE—OHE—EXISTING OVERHEAD ELECTRIC ---T--T--T--EXISTING TELECOM LINE ---G--G--G--G-- EXISTING GAS LINE

- 1. ALL WORK SHALL BE DONE IN ACCORDANCE WITH GOVERNING AGENCY STANDARDS AND SPECIFICATIONS. IN THE ABSENCE OF PROJECT STANDARD AND SPECIFICATIONS APWA STANDARD AND SPECIFICATIONS SHALL GOVERN.
- CONTRACTOR SHALL RETAIN AND PROTECT ALL EXISTING IMPROVEMENTS UNLESS OTHERWISE NOTED. CONTRACTOR IS RESPONSIBLE TO REPAIR ALL SIDEWALK, PAVEMENT, GRAVEL, UTILITIES, LANDSCAPING, IRRIGATION, FENCING AND EXISTING IMPROVEMENTS DAMAGED AS PART OF
- SIDEWALKS AND CURBS DESIGNATED TO BE DEMOLISHED SHALL BE DEMOLISHED TO THE NEAREST EXPANSION JOINT, MATCHING THESE PLANS AS CLOSELY AS POSSIBLE.
- 4. IT IS THE CONTRACTORS RESPONSIBILITY TO CONTACT BLUE STAKES OF UTAH PRIOR TO STARTING ANY ACTIVITIES. ALL EXISTING UTILITIES SHOWN ON THE PLANS ARE APPROXIMATIONS ONLY.
- EXISTING UNDERGROUND UTILITIES AND IMPROVEMENTS ARE SHOWN IN THEIR APPROXIMATE LOCATIONS BASED UPON RECORD INFORMATION AVAILABLE AT THE TIME OF PREPARATION OF THESE PLANS. LOCATIONS MAY NOT HAVE BEEN VERIFIED IN THE FIELD AND NO GUARANTEE IS MADE AS TO THE ACCURACY OR COMPLETENESS OF THE INFORMATION SHOWN. IT SHALL BE THE RESPONSIBILITY OF THE CONTRACTOR TO DETERMINE THEN EXISTENCE AND LOCATION OF THE UTILITIES SHOWN ON THESE PLANS OR INDICATED IN THE FIELD BY LOCATING SERVICES. ANY ADDITIONAL COSTS INCURRED AS A RESULT OF THE CONTRACTOR'S FAILURE TO VERIFY THE LOCATIONS OF EXISTING UTILITIES PRIOR TO THE BEGINNING OF CONSTRUCTION IN THEIR VICINITY SHALL BE BORNE BY THE CONTRACTOR AND ASSUMED INCLUDED IN THE CONTRACT. THE CONTRACTOR IS TO VERIFY ALL CONNECTION POINTS WITH THE EXISTING UTILITIES. THE CONTRACTOR IS RESPONSIBLE FOR ANY DAMAGE CAUSED TO THE EXISTING UTILITIES AND UTILITY STRUCTURES THAT ARE TO REMAIN. IF CONFLICTS WITH EXISTING UTILITIES OCCUR, THE CONTRACTOR SHALL NOTIFY THE ENGINEER PRIOR TO CONSTRUCTION TO DETERMINE IF ANY FIELD ADJUSTMENTS SHOULD BE MADE. ENSURE ALL OSHA STANDARDS ARE FOLLOWED.
- 4. CONTRACTOR IS RESPONSIBLE TO PROVIDE, INSTALL AND MAINTAIN APPROPRIATE TRAFFIC CONTROL DEVICES, AS WELL AS ANY ADDITIONAL TRAFFIC CONTROL DEVICES THAT MAY BE REQUIRED TO INSURE SAFE AND EFFICIENT MOVEMENT OF TRAFFIC AND PEDESTRIANS THROUGH OR AROUND THE WORK AREA AND TO PROVIDE MAXIMUM PROTECTION AND SAFETY TO
- SHALL CONFORM TO THE LATEST EDITION OF THE M.U.T.C.D. (MANUAL ON UNIFORM TRAFFIC CONTROL DEVICES). THE CONTRACTOR WILL MAINTAIN SUCH SO THAT THEY ARE PROPERLY PLACED AND VISIBLE AT ALL TIMES.
- 6. IF DURING THE CONSTRUCTION PROCESS, CONDITIONS ARE ENCOUNTERED WHICH INDICATE AN UNIDENTIFIED SITUATION IS PRESENT, THE CONTRACTOR SHALL CONTACT THE OWNER AND ENGINEER IMMEDIATELY.
- 7. ALL TREE REMOVAL AND PLANTING IN THE PUBLIC RIGHT OF WAY REQUIRES A PERMIT AND SHALL COMPLY WITH SALT LAKE CITY URBAN FORESTRY TREE PROTECTION AND PRESERVATION POLICY.
- TREES ARE TO REMAIN UNLESS NOTED OTHERWISE.
- PRIOR TO WORKING IN THE PUBLIC RIGHT OF WAY, A LICENSED, INSURED, AND BONDED CONTRACTOR, WHO HAS SAID INFORMATION ON FILE WITH SLC ENGINEERING, MUST OBTAIN A PUBLIC WAY PERMIT FROM SLC ENGINEERING AND PERHAPS A TRANSPORTATION PERMIT. ALL WORK IN PUBLIC RIGHT OF WAY SHALL FOLLOW APWA STANDARD PLANS.
- 10. REPAIR ALL STREET CUTS PER APWA PLAN #255 (SEE DETAIL-T ON
- 11. CONTRACTOR TO APPLY FOR PUBLIC UTILITIES DEMOLITION PERMIT THROUGH THE PUBLIC UTILITIES CONTRACTS OFFICE. THIS PERMIT IS SEPARATE FROM THE BUILDING DEMOLITION PERMIT.
- 12. THE SWPPP BOOK AND UPDES PERMIT SHALL BE PROVIDED BY THE
- 13. COORDINATE WITH ROCKY MOUNTAIN POWER FOR ELECTRICAL SERVICE
- 14. COORDINATE WITH DOMINION ENERGY FOR GAS SERVICE LINE REMOVAL.

BENCHMARK

FOUND STREET MONUMENT (FLAT BRASS) 900 SOUTH & 400 W INTERSECTION ELEVATION=4231.85 (NAVD88)




_	OBIC DATE.	4720				
	000. VAIE.	7/20				
	SURVEY BY: PEPG CREW	PPG CREW				
	DRAWN BY:	TRC				
	DESIGNED BY .	TRC				
	CHECKED BY:	RLK				
	SCALE:	1"=10'	Ç	WOLLUNG	L F	, 0
1			NO.	NU. DESCRIPTION	DAIE	AFF D

PARTMENTS

TH 400 WEST

THOUS & DEMOLIT

SOHI / **927 SOI**

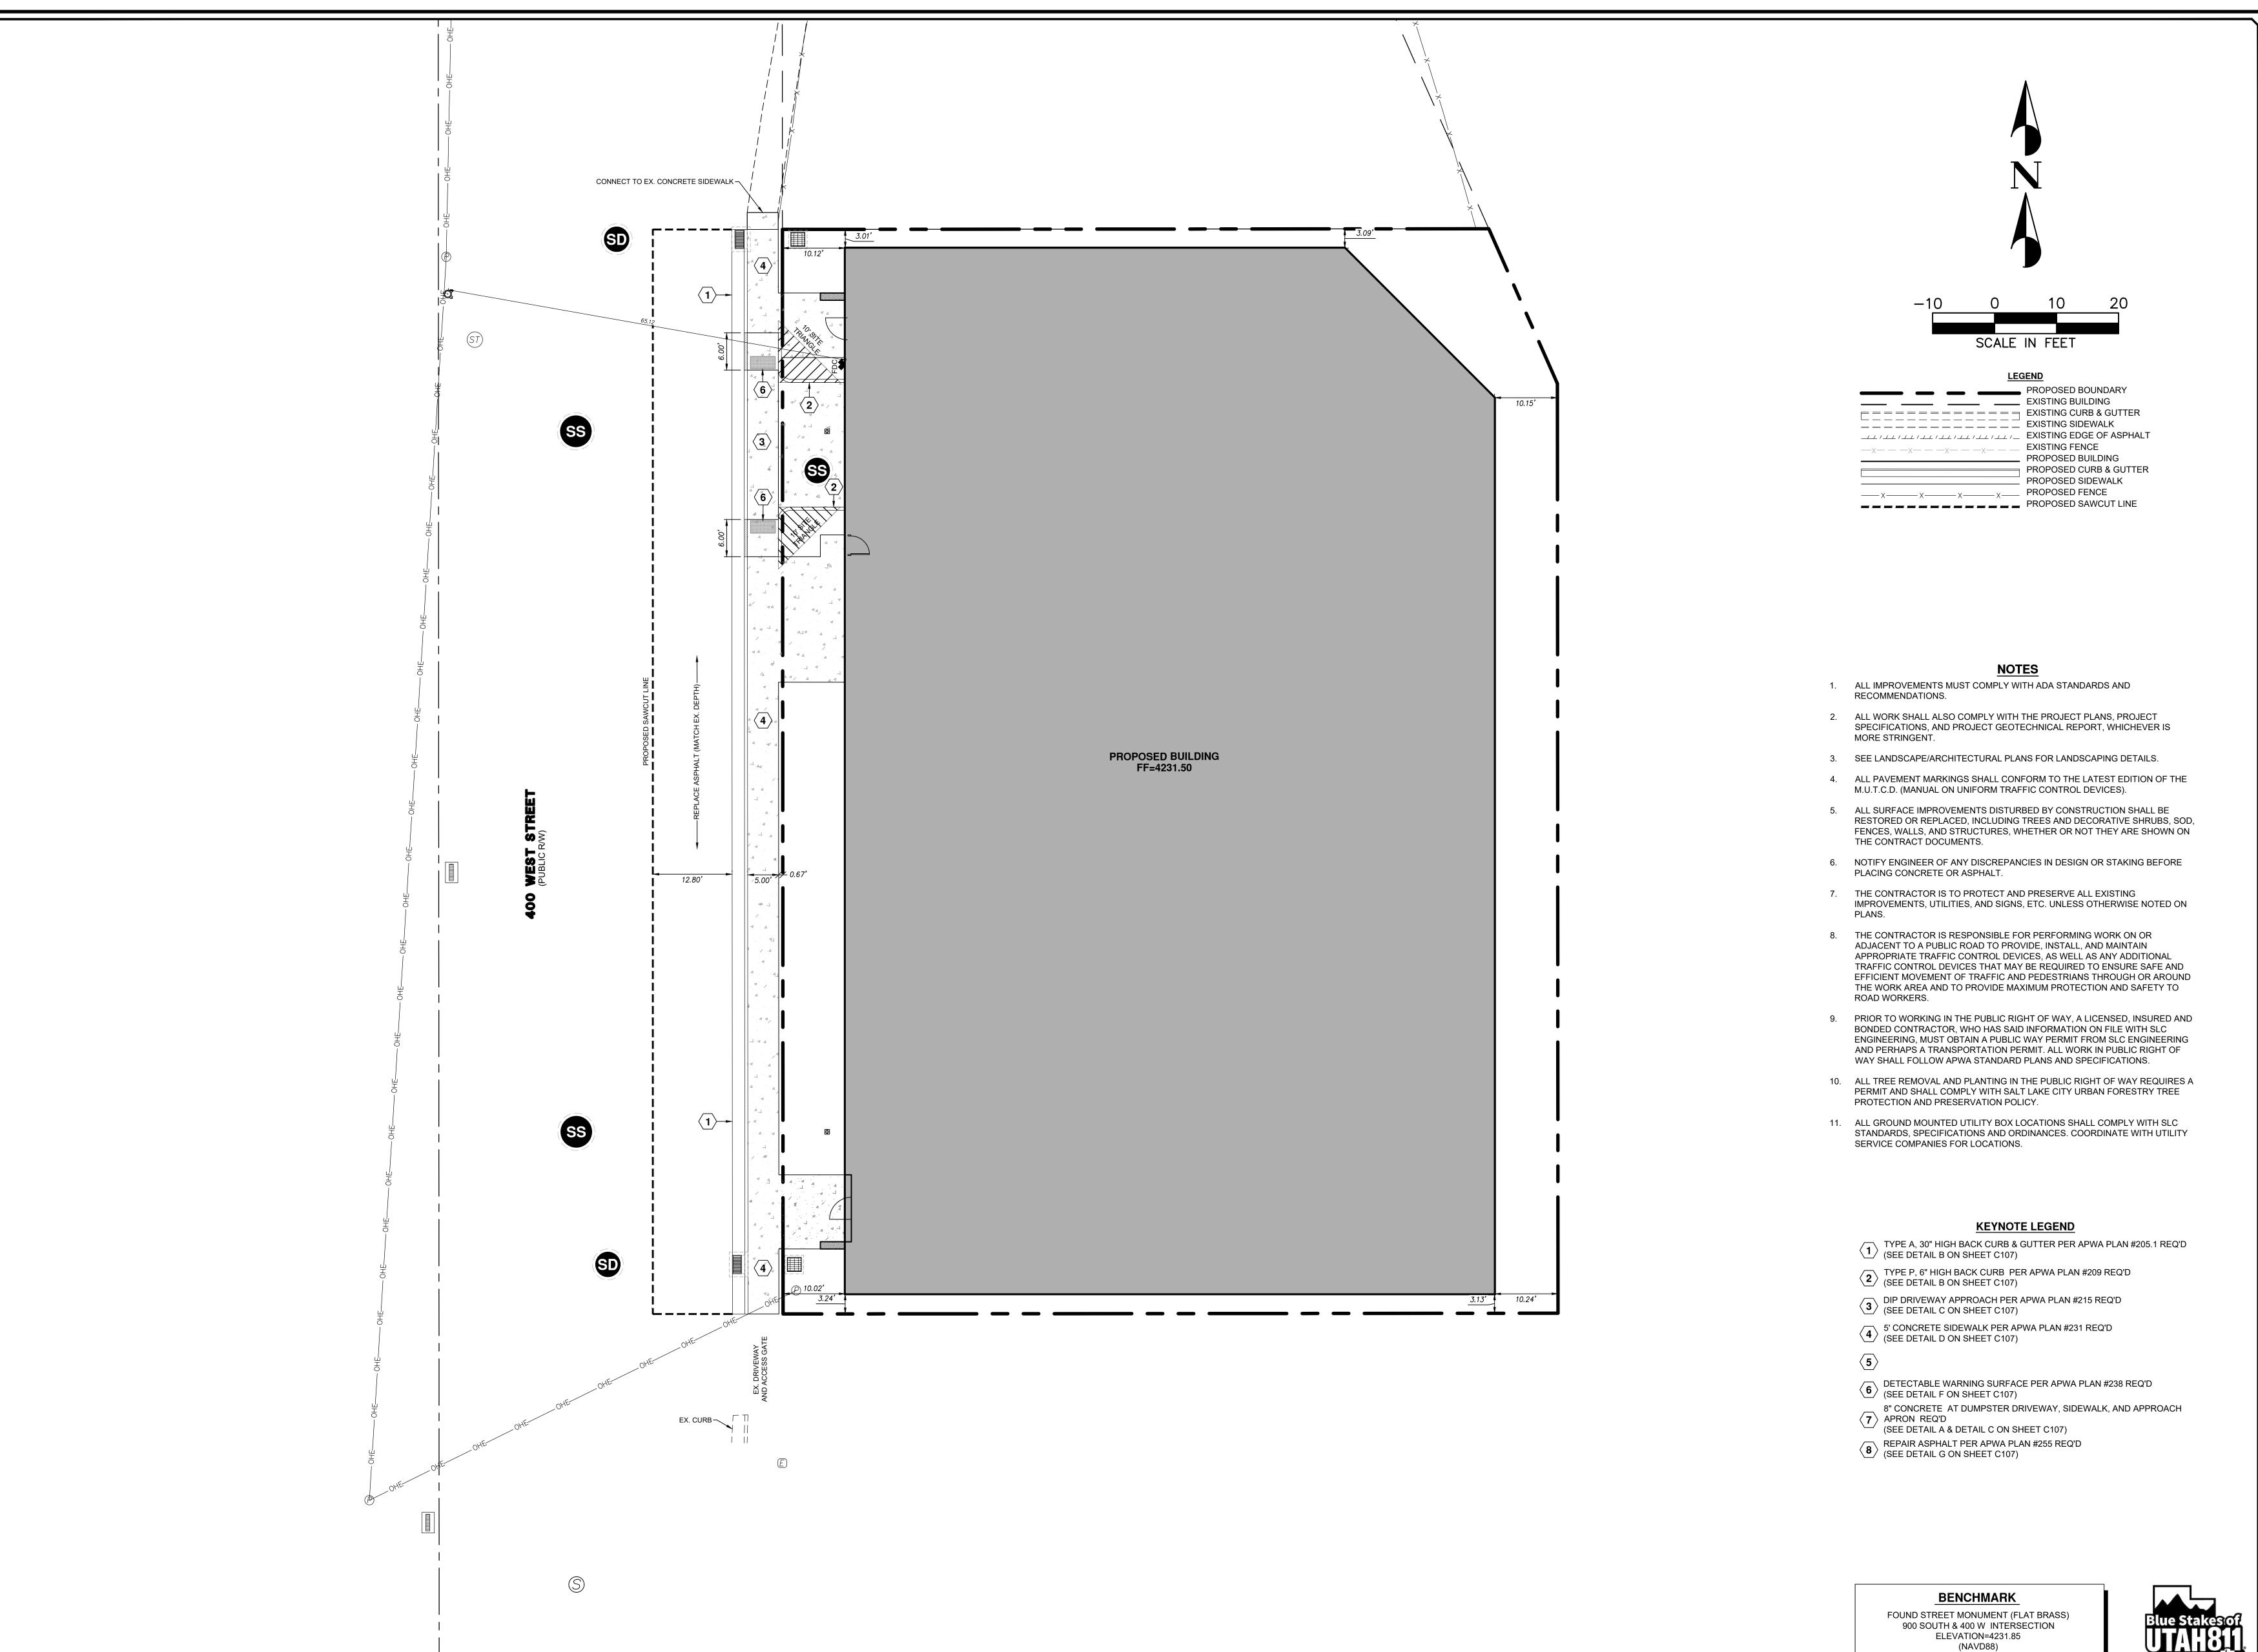

 ORIG. DATE:
 4/20

 SURVEY BY:
 TRC

 DRAWN BY:
 TRC

 DESIGNED BY:
 TRC

 CHECKED BY:
 RLK

 SCALE:
 1"=10"

 NO.
 DESCRIPTION

CONSULTINE
270 SOUTH 300 WEST • SANDY, UT 84070
3NE: (801) 562-2521 • FAX: (801) 562-2551
SINEERING · LAND SURVEYING · PROJECT MANAGEMEN

SOHI APARTMENTS

27 SOUTH 400 WEST


SITE
PLAN


927 NUGUST 10, 2020

SALT LAKE CITY



[SHEET NO. <u>**C10**</u>

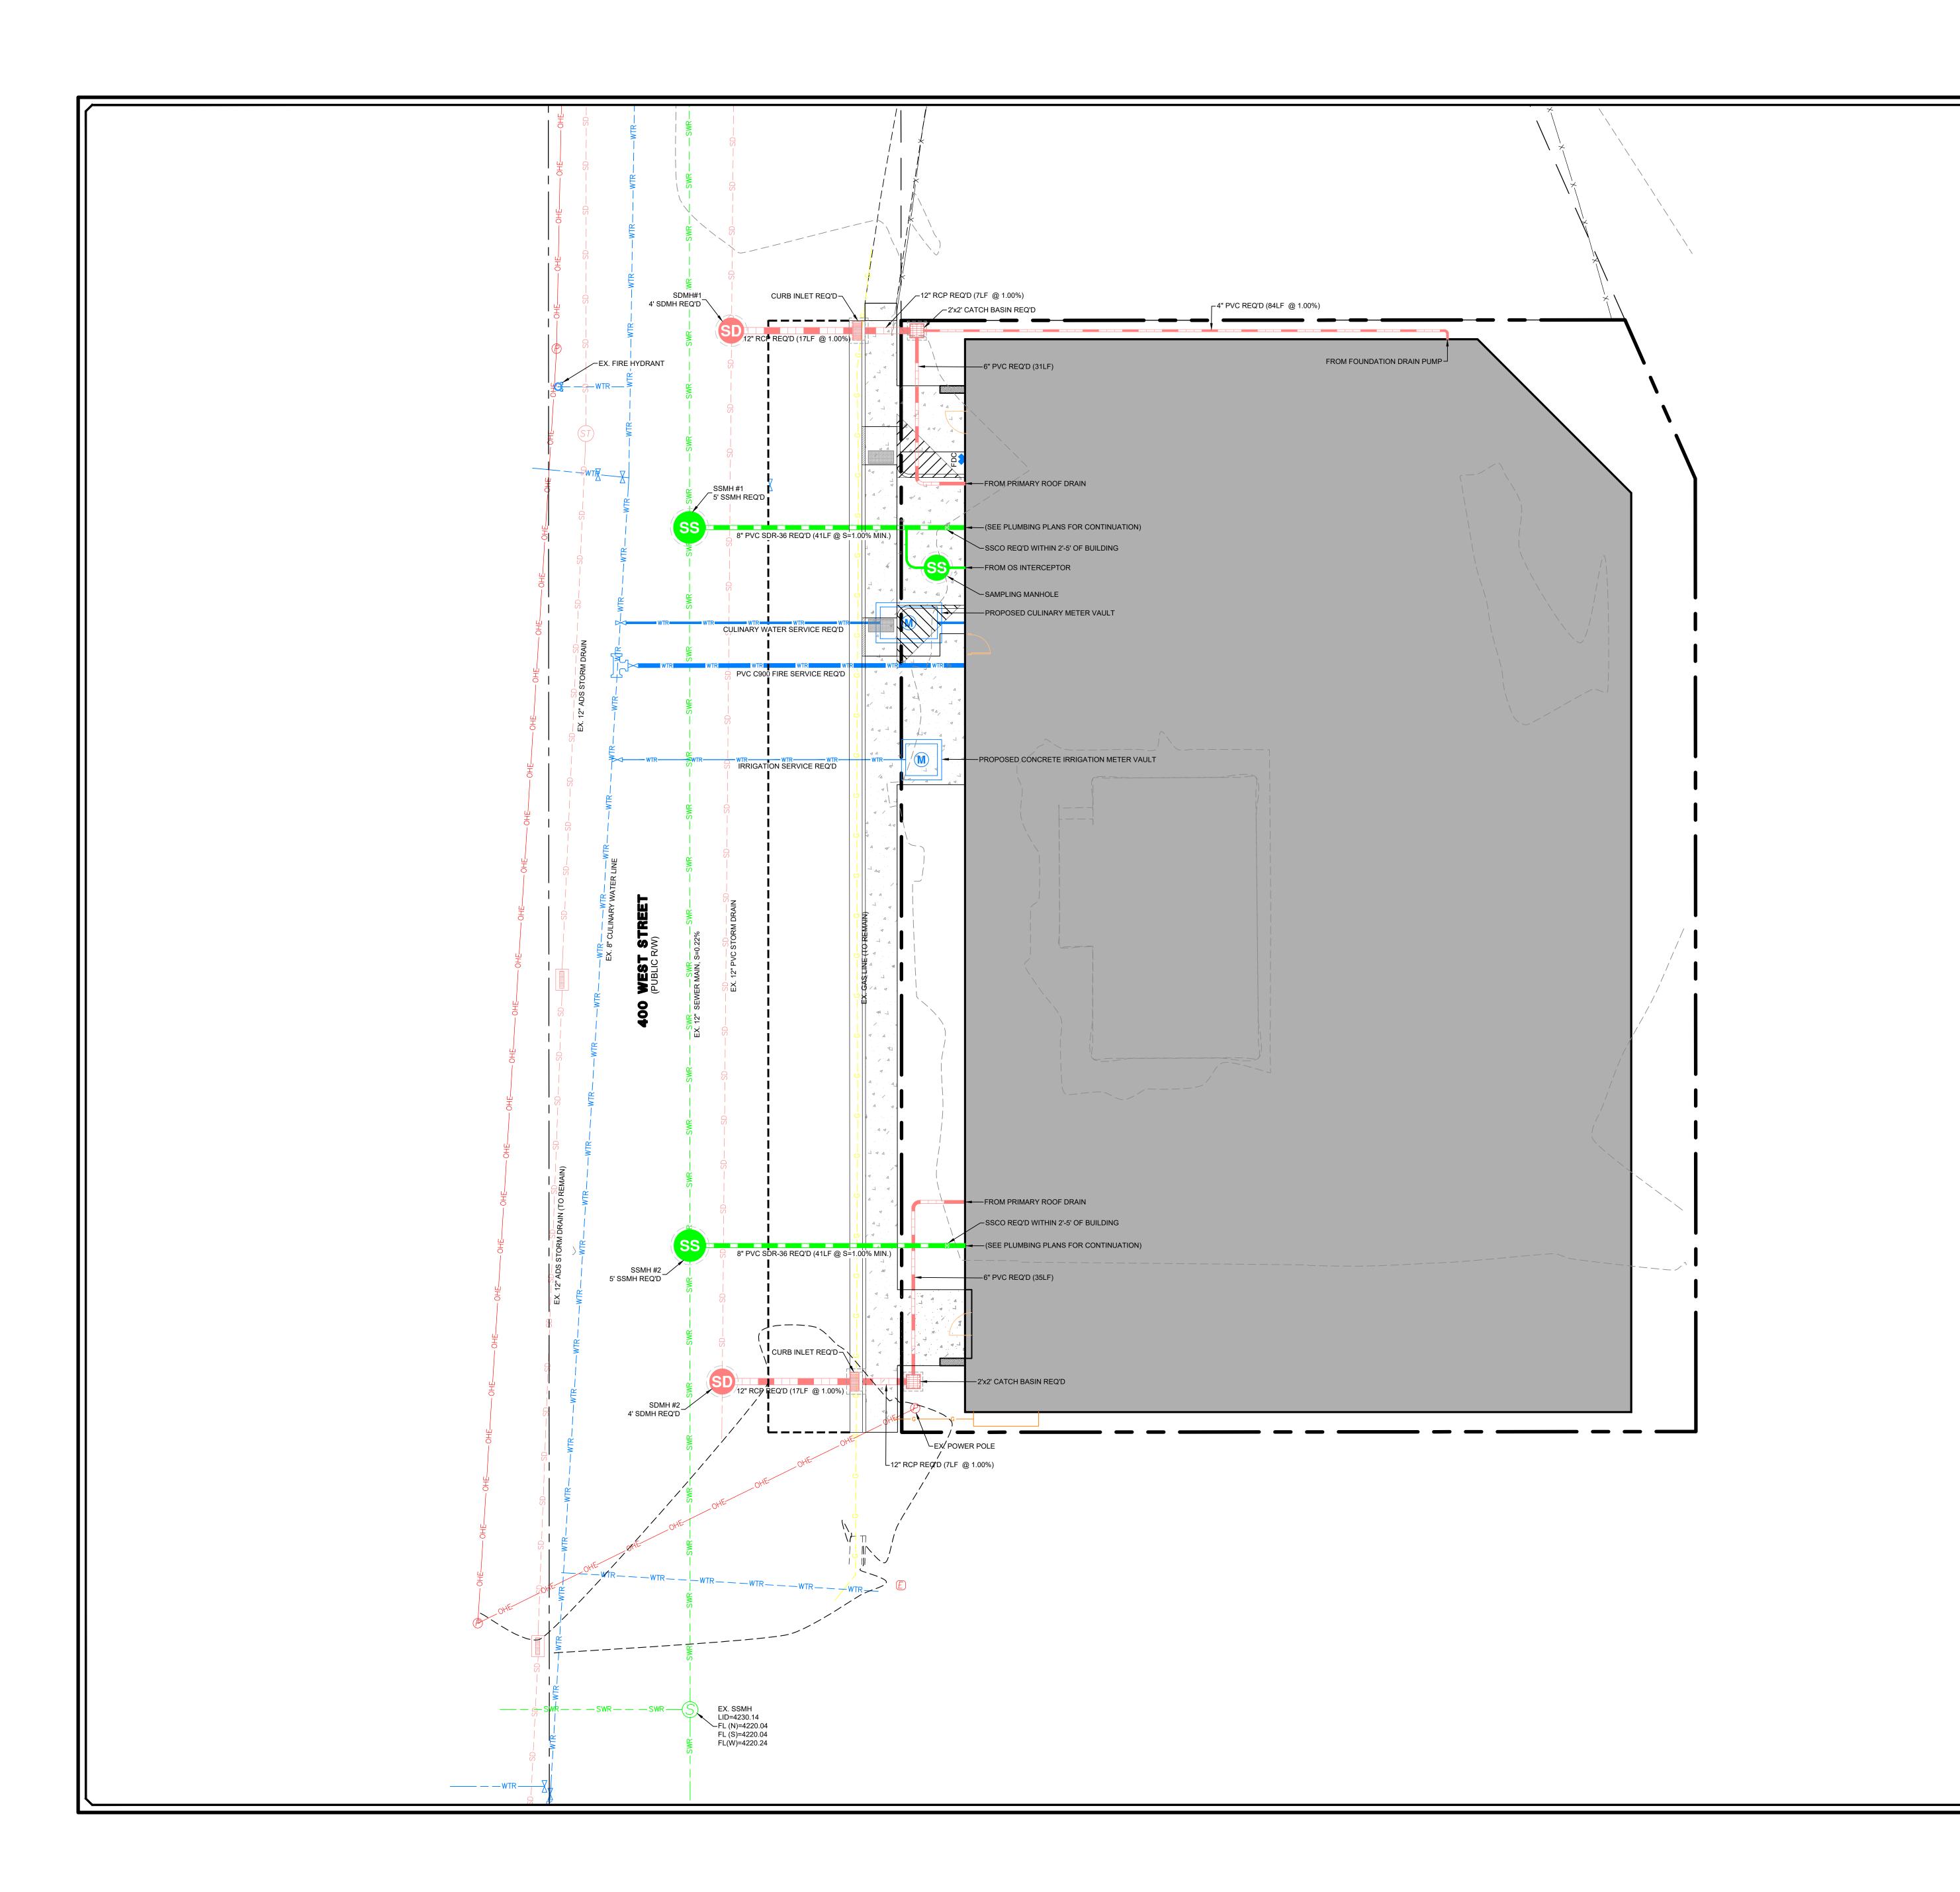

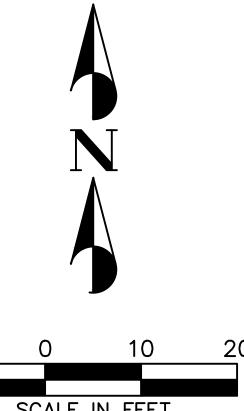

—— —— EXISTING BUILDING -X- -X- -X- -X- -X- EXISTING FENCE — — — WTR — — WTR — EXISTING WATER LINE -- - SWR-- - SWR- - SWR- EXISTING SEWER LINE —— OHE—— OHE—— OHE—— EXISTING OVERHEAD ELECTRIC ---T--T--EXISTING TELECOM LINE

PROPOSED CURB & GUTTER

——X———X———X——— PROPOSED FENCE WTR WTR PROPOSED WATER LINE PROPOSED SEWER LINE PROPOSED STORM DRAIN LINE PROPOSED SAWCUT LINE

SCALE IN FEET

PROPOSED BOUNDARY

PROPOSED BUILDING PROPOSED SIDEWALK

SHEET NO. **C103**

BENCHMARK

ENSURE UTILITIES ARE SEPARATED AS NOTED IN THE TABLE BELOW

UTILITY 2

CULINARY WATER

STORM DRAIN

SEWER

SEWER

SEWER

UTILITY 1

CULINARY WATER

CULINARY WATER

CULINARY WATER

FIRE WATER

FIRE WATER

STORM DRAIN

SEWER

HORIZONTAL VERTICAL

CLEARANCE | CLEARANCE

3 FEET 12 INCHES

10 FEET 18 INCHES

3 FEET 12 INCHES

3 FEET 12 INCHES


10 FEET 18 INCHES

5 FEET 12 INCHES

3 FEET | 12 INCHES

12 INCHES

FOUND STREET MONUMENT (FLAT BRASS) 900 SOUTH & 400 W INTERSECTION ELEVATION=4231.85 (NAVD88)

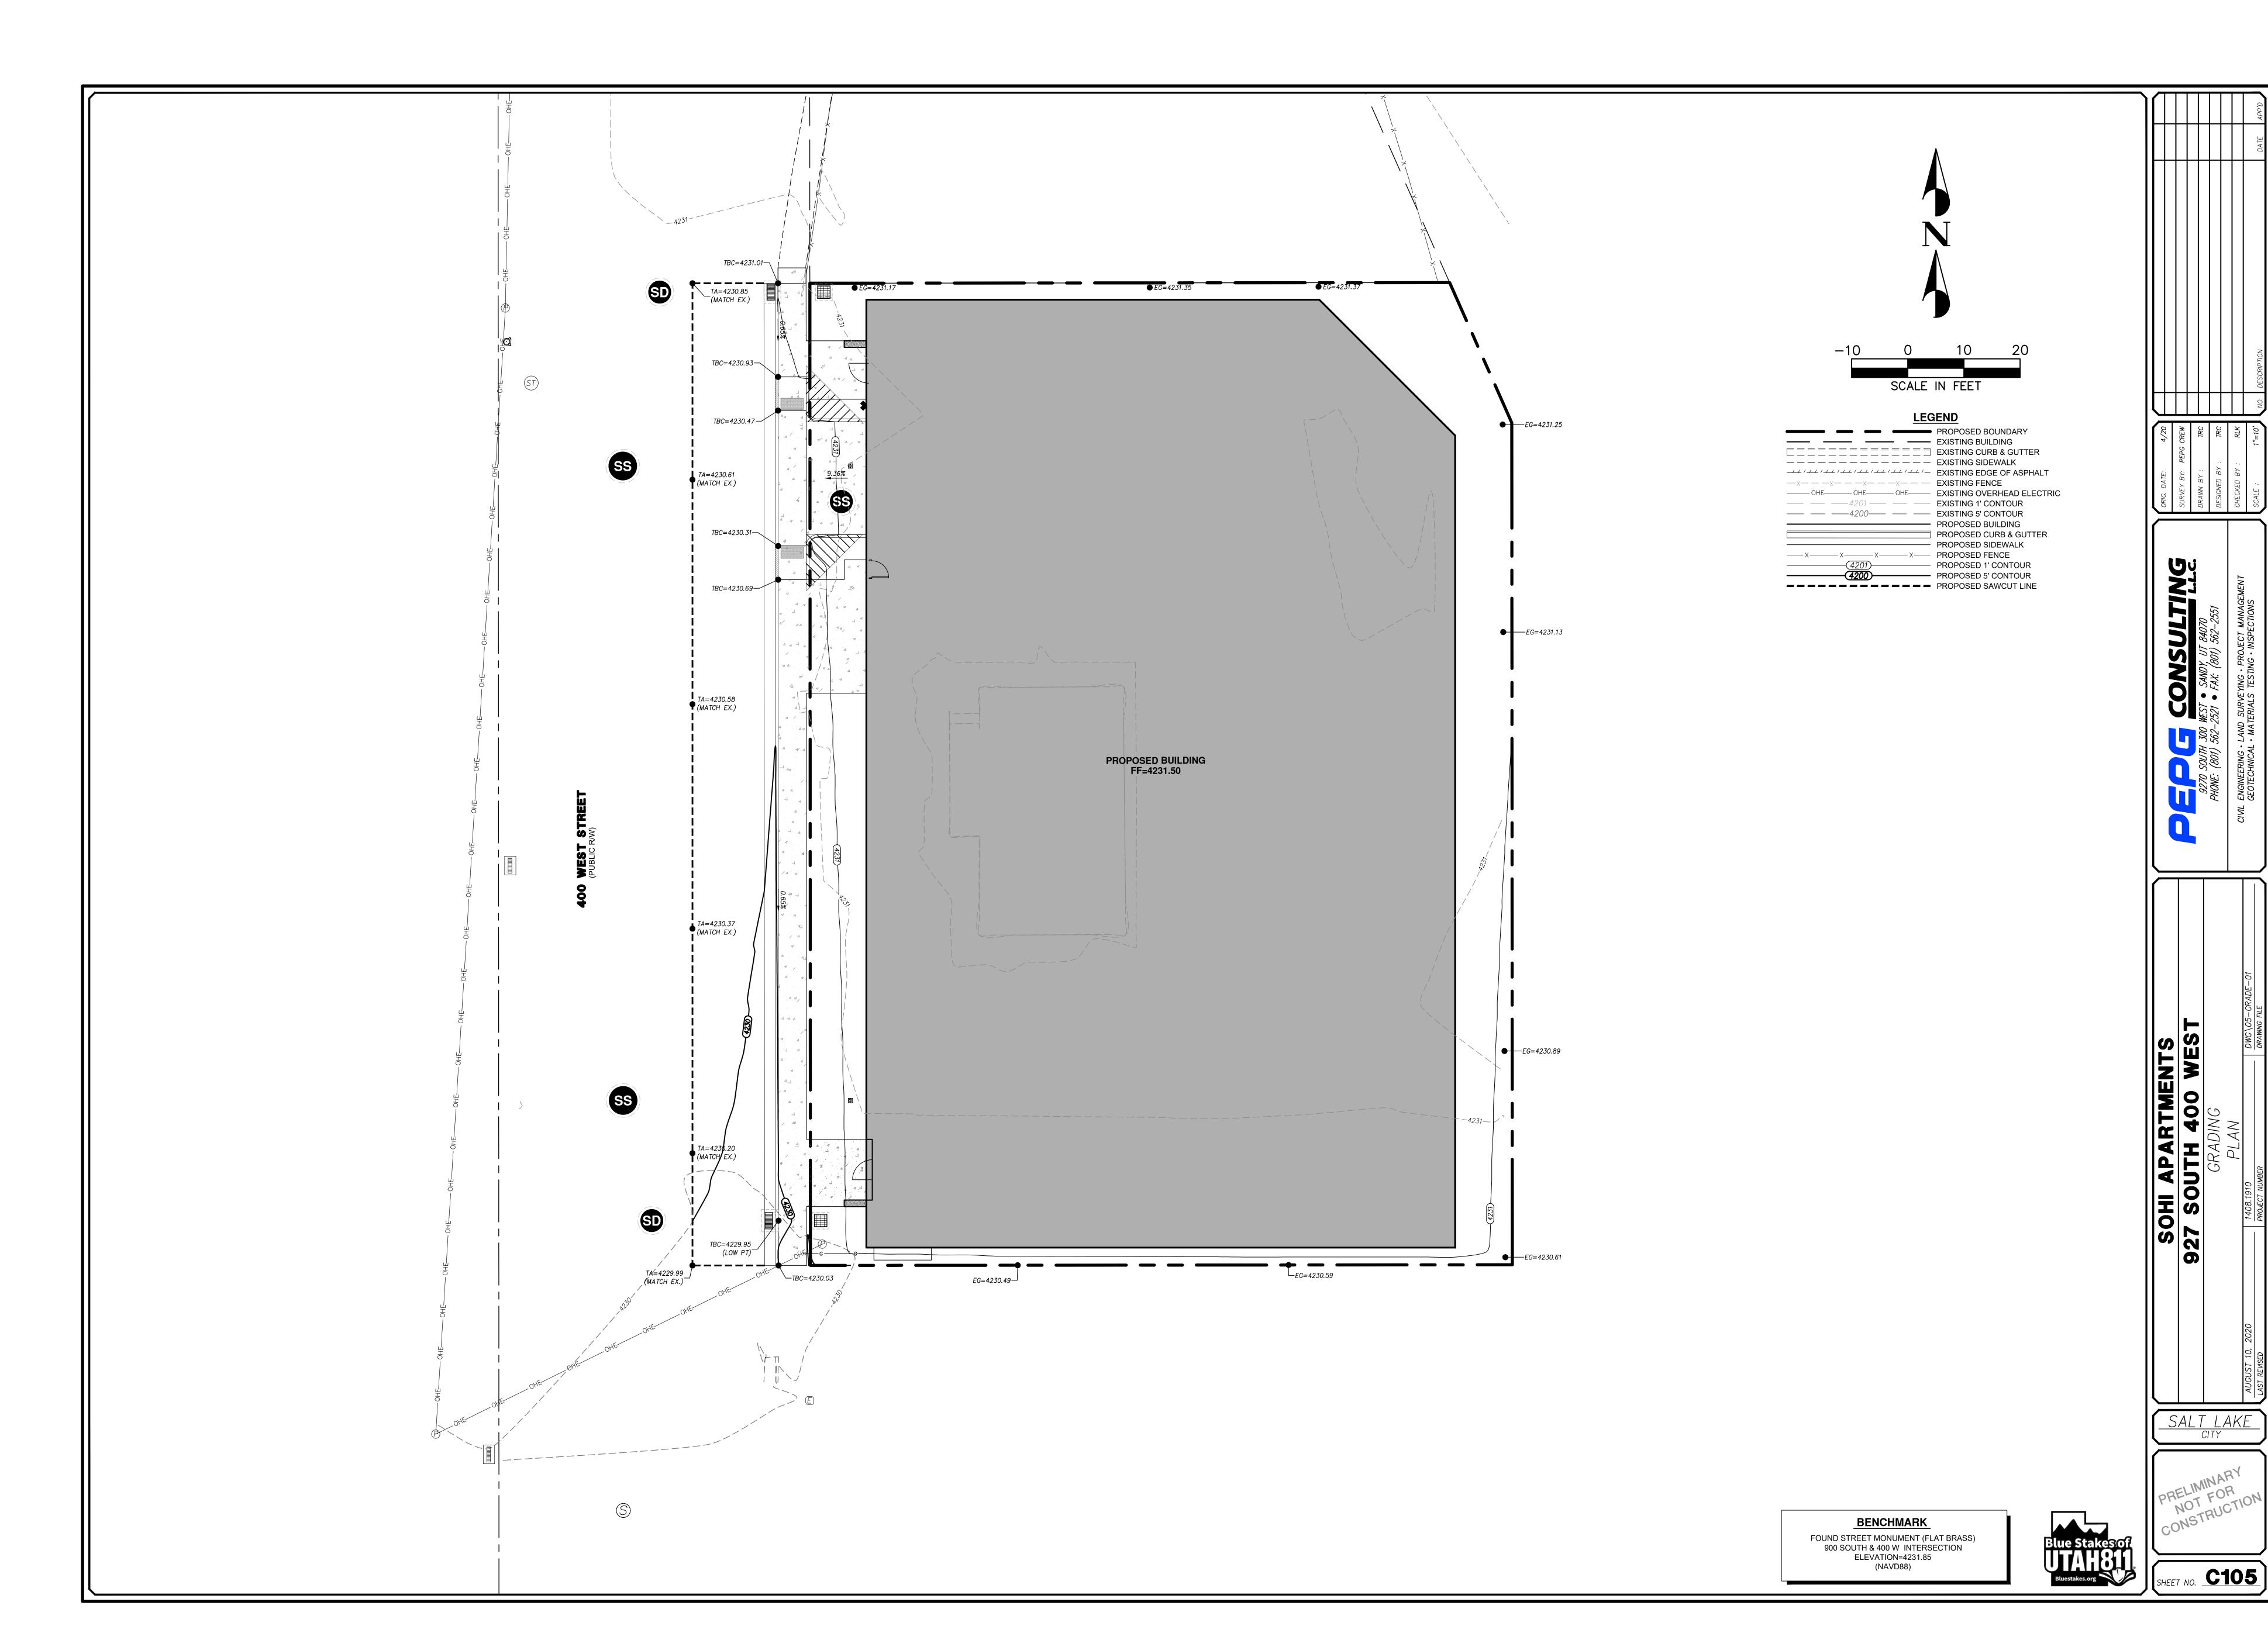

PLANT SCHEDULE


<u>QTY</u> 8
6
QTY
51
62
46
QTY
2,498 SF
QTY
947 SF
I <u>G</u>

SUMMARY DATA


21,719 SF 6,235 SF TOTAL SITE: **OPEN SPACE AREA:** TOTAL VEGETATED AREA: 978 SF

DROUGHT TOLERANT TREES AND SHRUBS(80% MINIMUM): TREES: 100% PROVIDED - NOTE HYDROZONES ON PLANTING SCHEDULE SHRUBS: 100% PROVIDED - NOTE HYDROZONES ON PLANTING SCHEDULE

PLEASE NOTE: TREE REMOVAL OR TREE PLANTING IN THE PUBLIC WAY REQUIRES APPROVAL FROM THE SLC URBAN FORESTRY (972-7818)

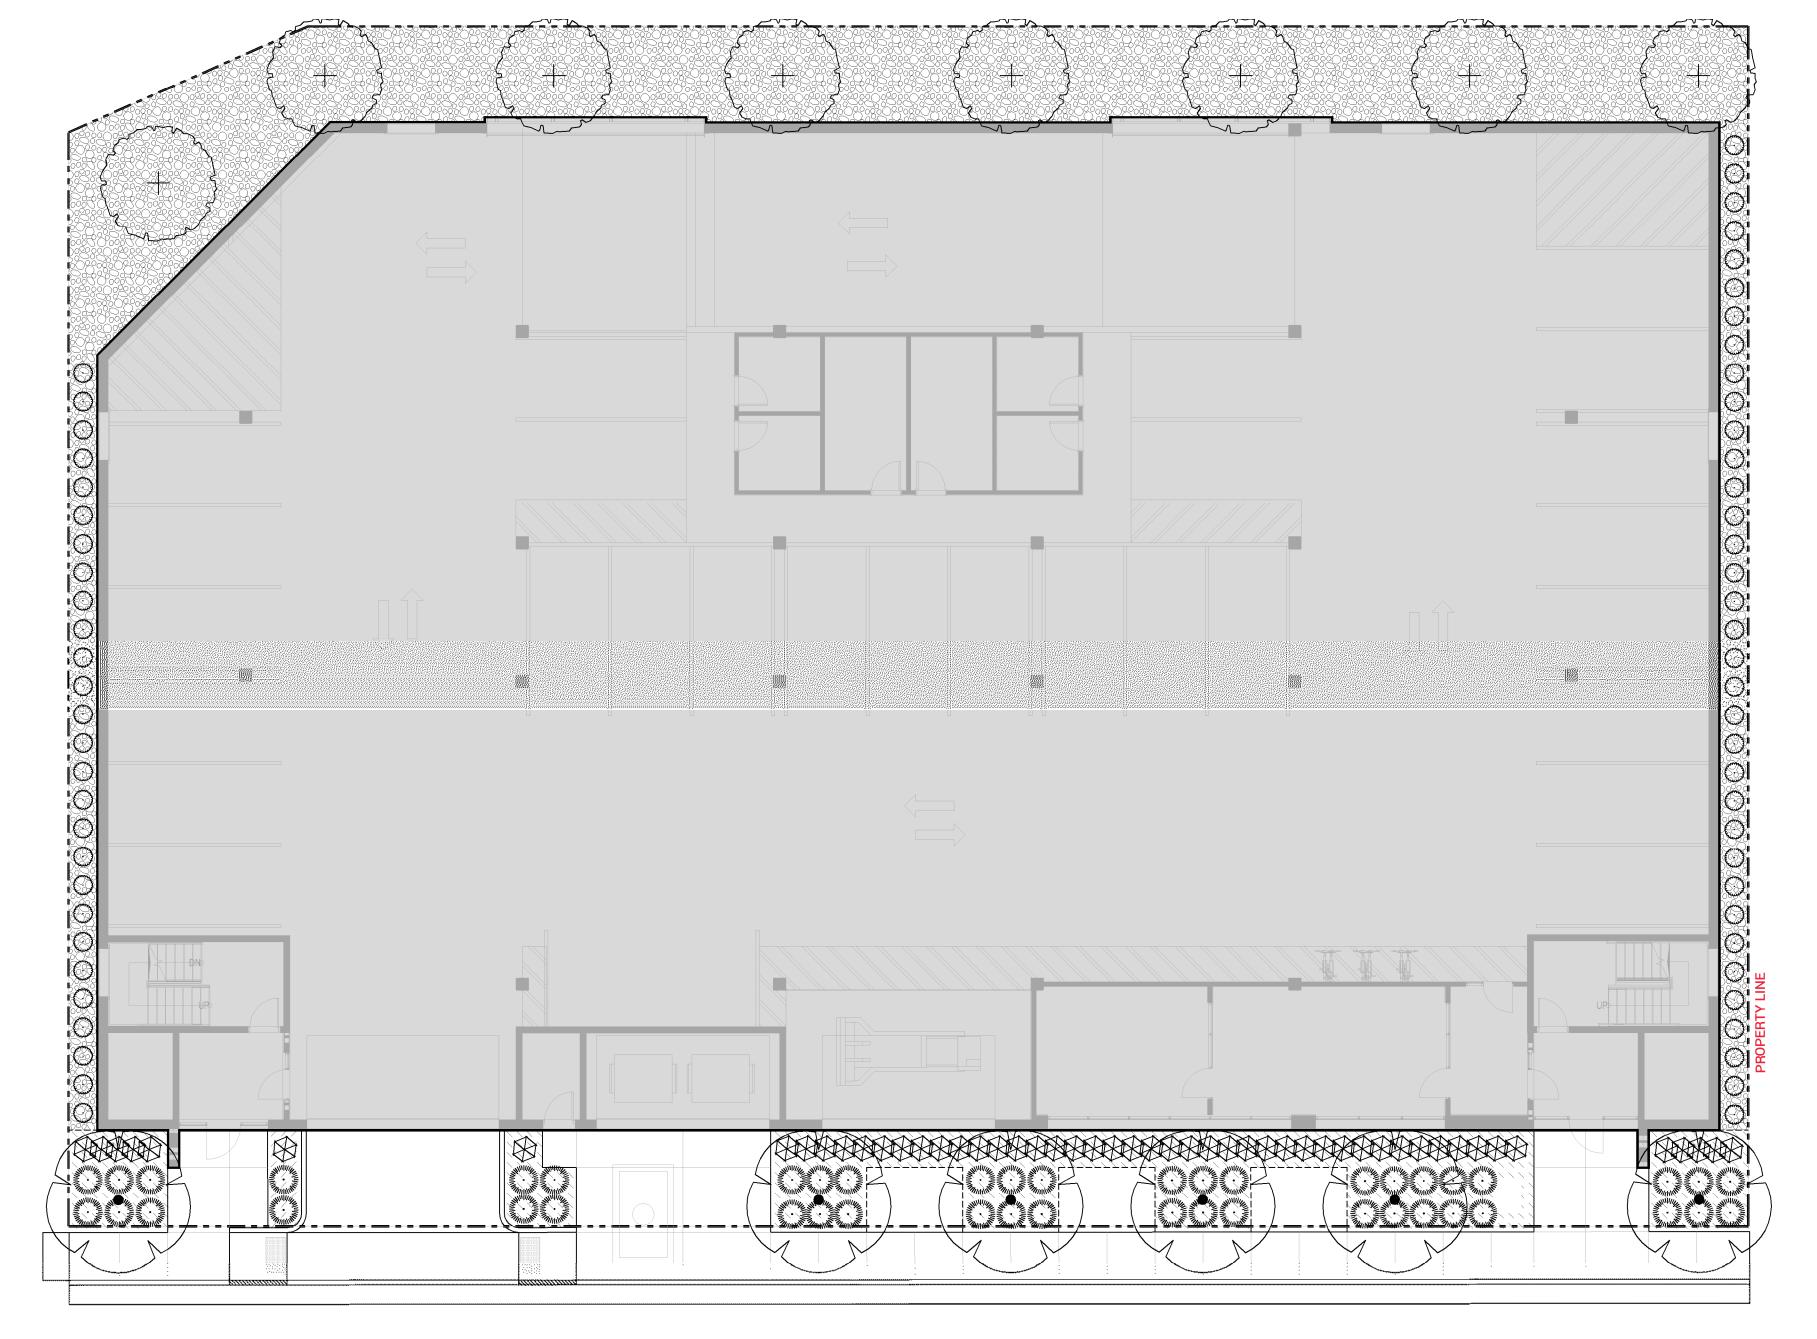

400 WEST STREET

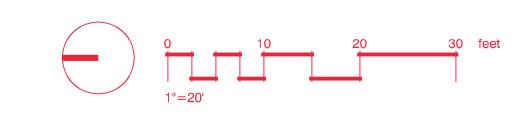

PROJECT NUMBER LANDSCAPE PLAN

DRAWING NUMBER

This drawing, as an instrument of professional service, is the property of BEECHER, WALKER & ASSOCIATES L.C. and shall not be used, in whole or part, for any cuter project without the written permission of an authorized

U

С

_

В

J

RINTED AT


1


SUMMARY DATA

TOTAL SITE: 21,719 SF
OPEN SPACE AREA: 6,235 SF

TOTAL VEGETATED AREA: 978 SF

DROUGHT TOLERANT TREES AND SHRUBS(80% MINIMUM):
TREES: 100% PROVIDED - NOTE HYDROZONES ON PLANTING SCHEDULE
SHRUBS: 100% PROVIDED - NOTE HYDROZONES ON PLANTING SCHEDULE
PLEASE NOTE: TREE REMOVAL OR TREE PLANTING IN
THE PUBLIC WAY REQUIRES APPROVAL FROM
THE SLC URBAN FORESTRY (972-7818)

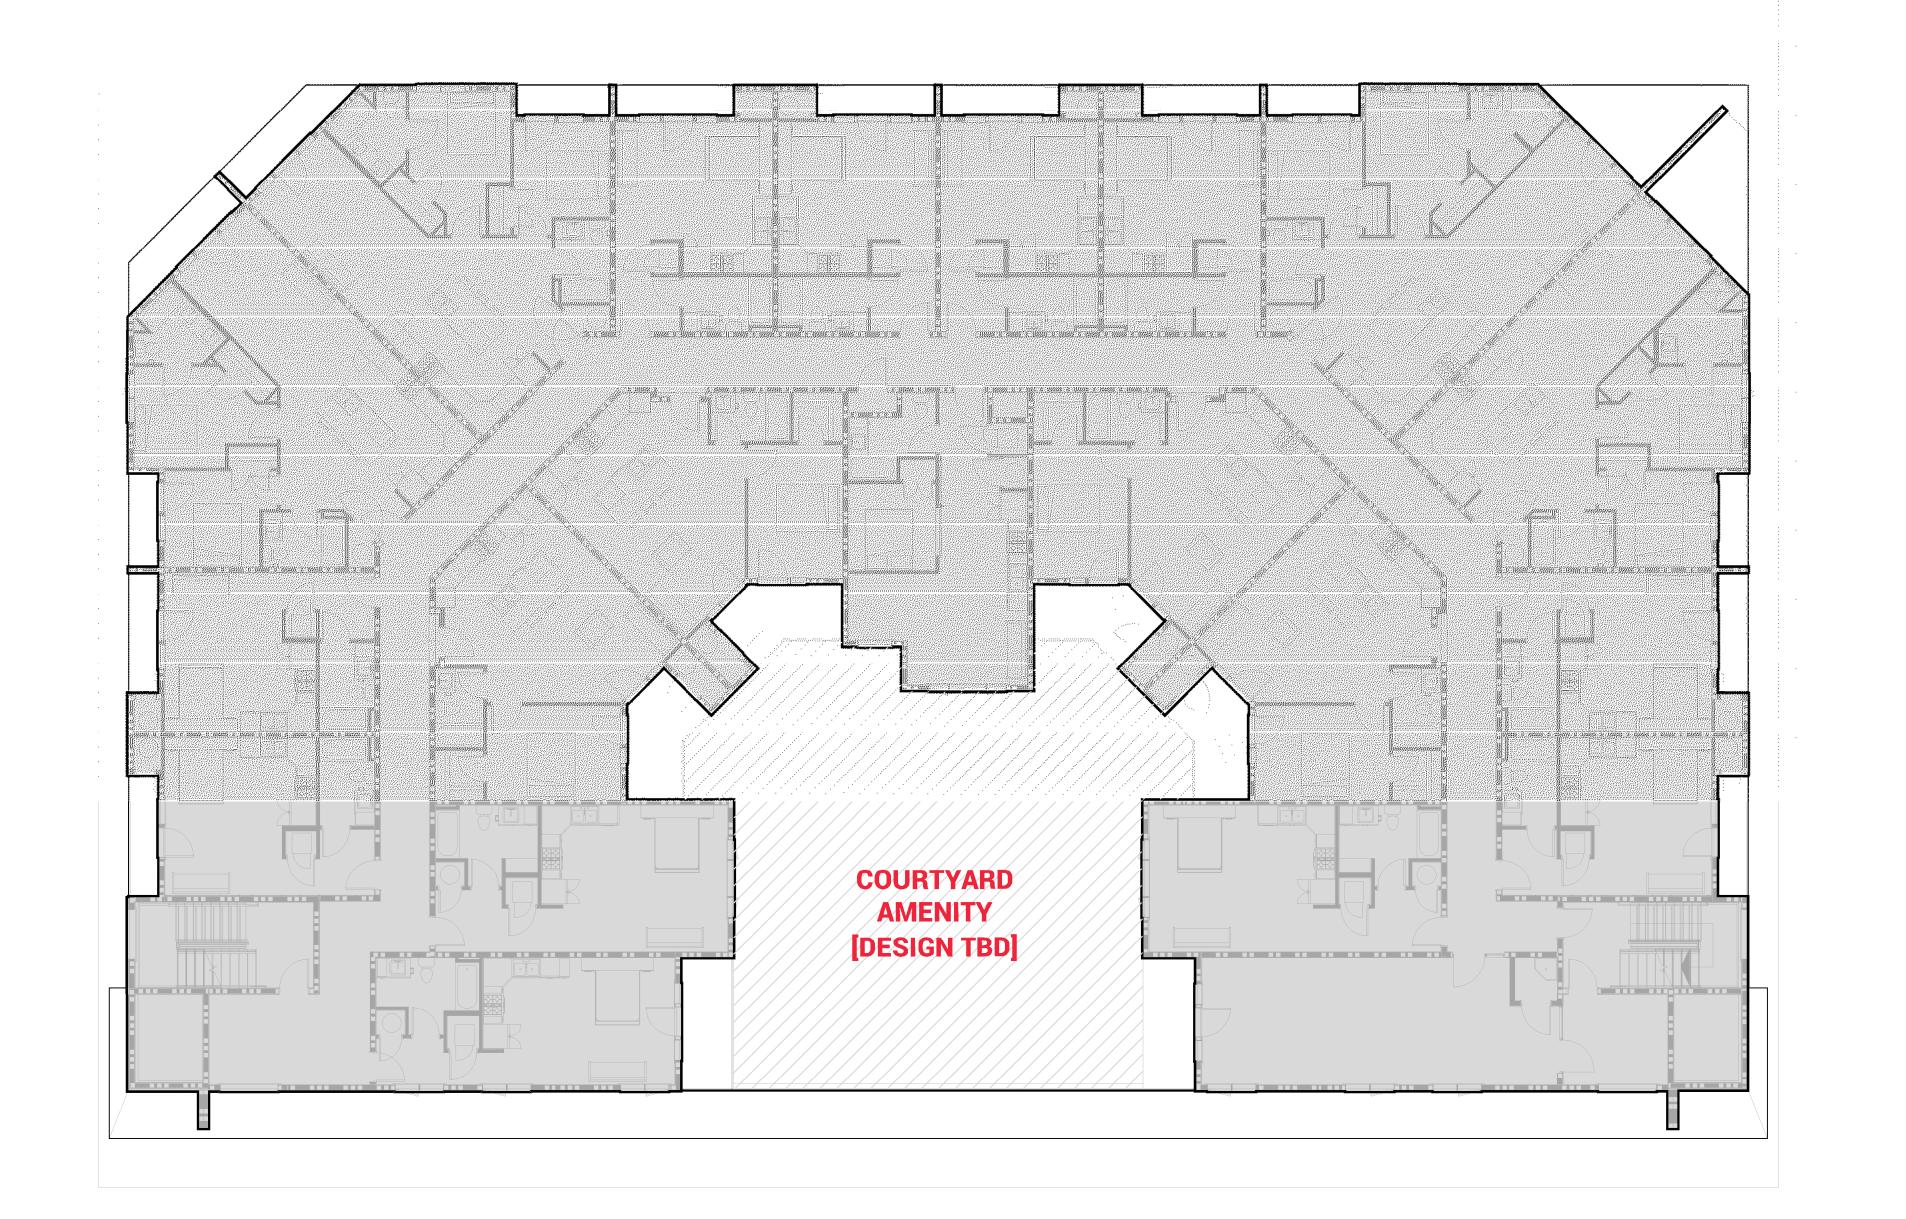

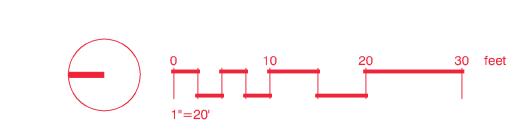

MARK ISSUE DESCRIPTION ISS. DATE # REV. DESCRIPTION R
SD SCHEMATIC DESIGN 06.03.2020

D

HI APARMENTS SOUTH 400 WEST T LAKE CITY, UTAH 84101

Secherwarker.com


PROJECT NUMBER
462.1905

DWN BY CHKD BY
KCF BAR

SCHEMATIC

LANDSCAPE PLAN

L102

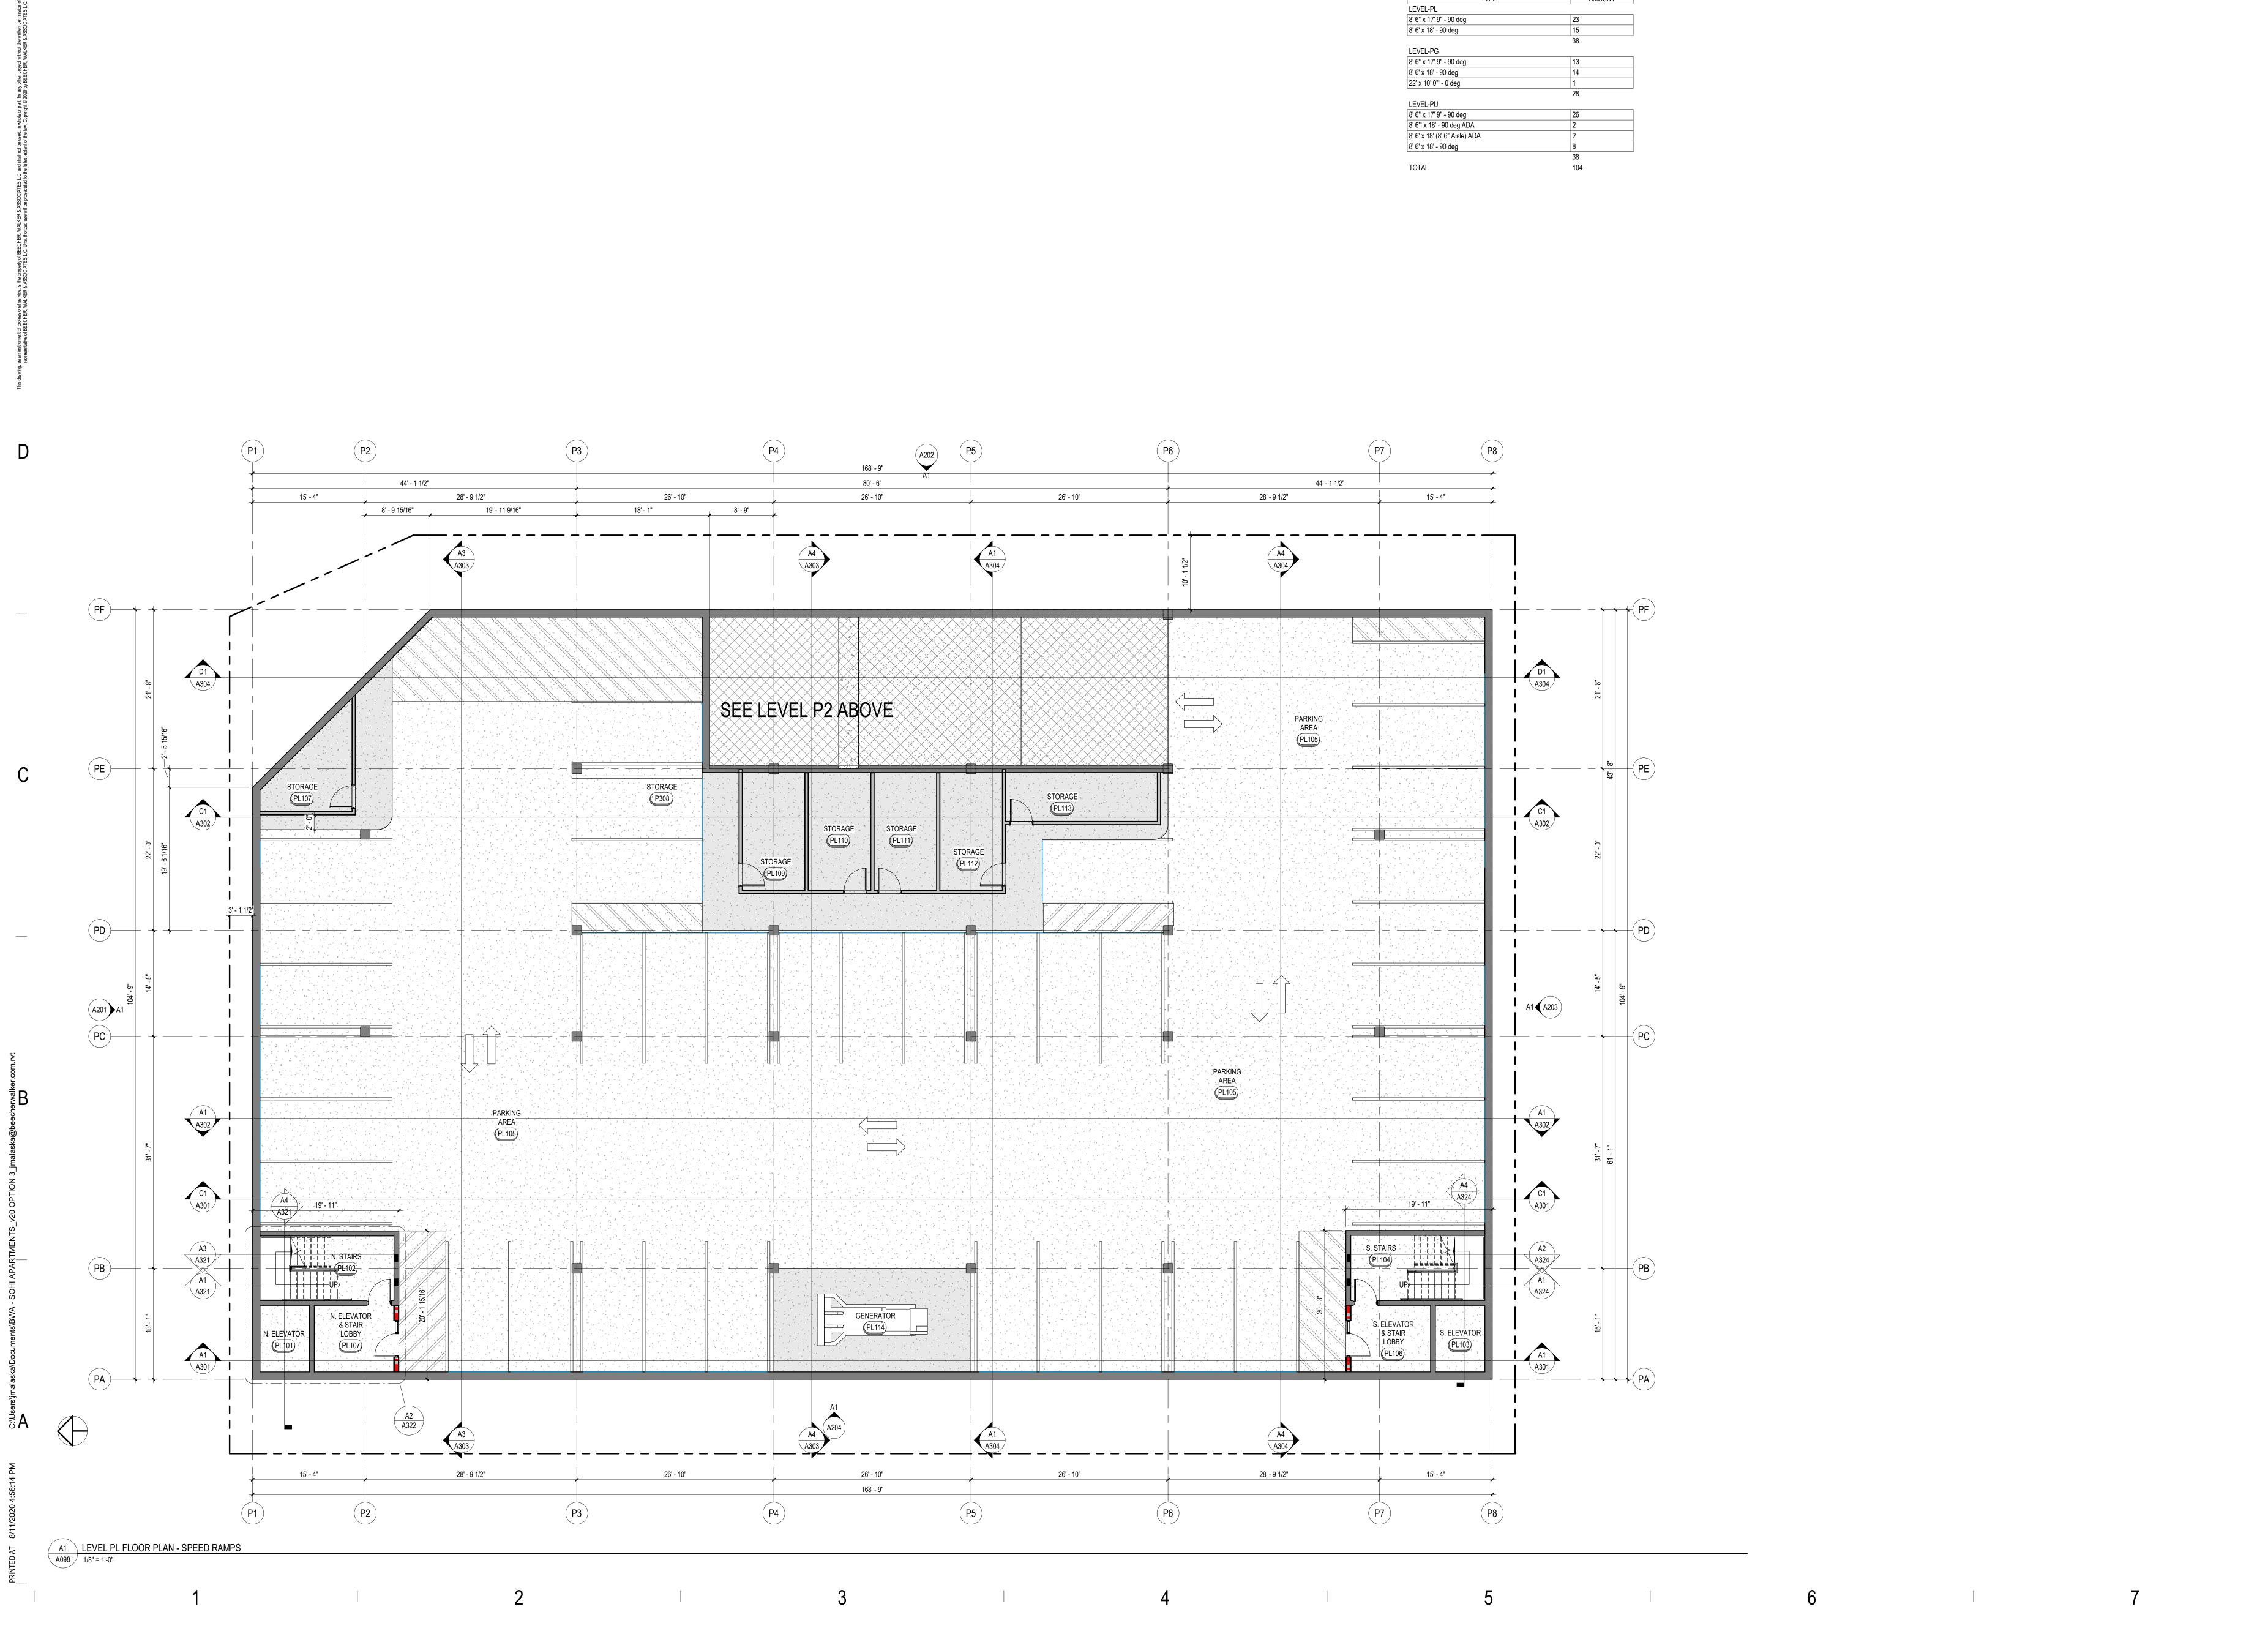

PARKING SCHEDULE - SPEED RAMPS

MARK ISSUE DESCRIPTION ISS. DATE # REV. DESCRIPTION REV. DATE

SD SCHEMATIC DESIGN 06.03.2020

2 SITE PLAN REVIEW 8-11-2020

D

OHI APARMENTS 27 SOUTH 400 WEST ALT LAKE CITY, UTAH 84101


Architecture/Interiors

O. 801.438.9500 | 3115 EAST LION LANE, #200 | BEECHERWALKER.COM

f. 801.438.9501 | HOLLADAY, UTAH 84121 | BEECHERWALKER.COM

LEVEL PL FLOOR PLAN

A09

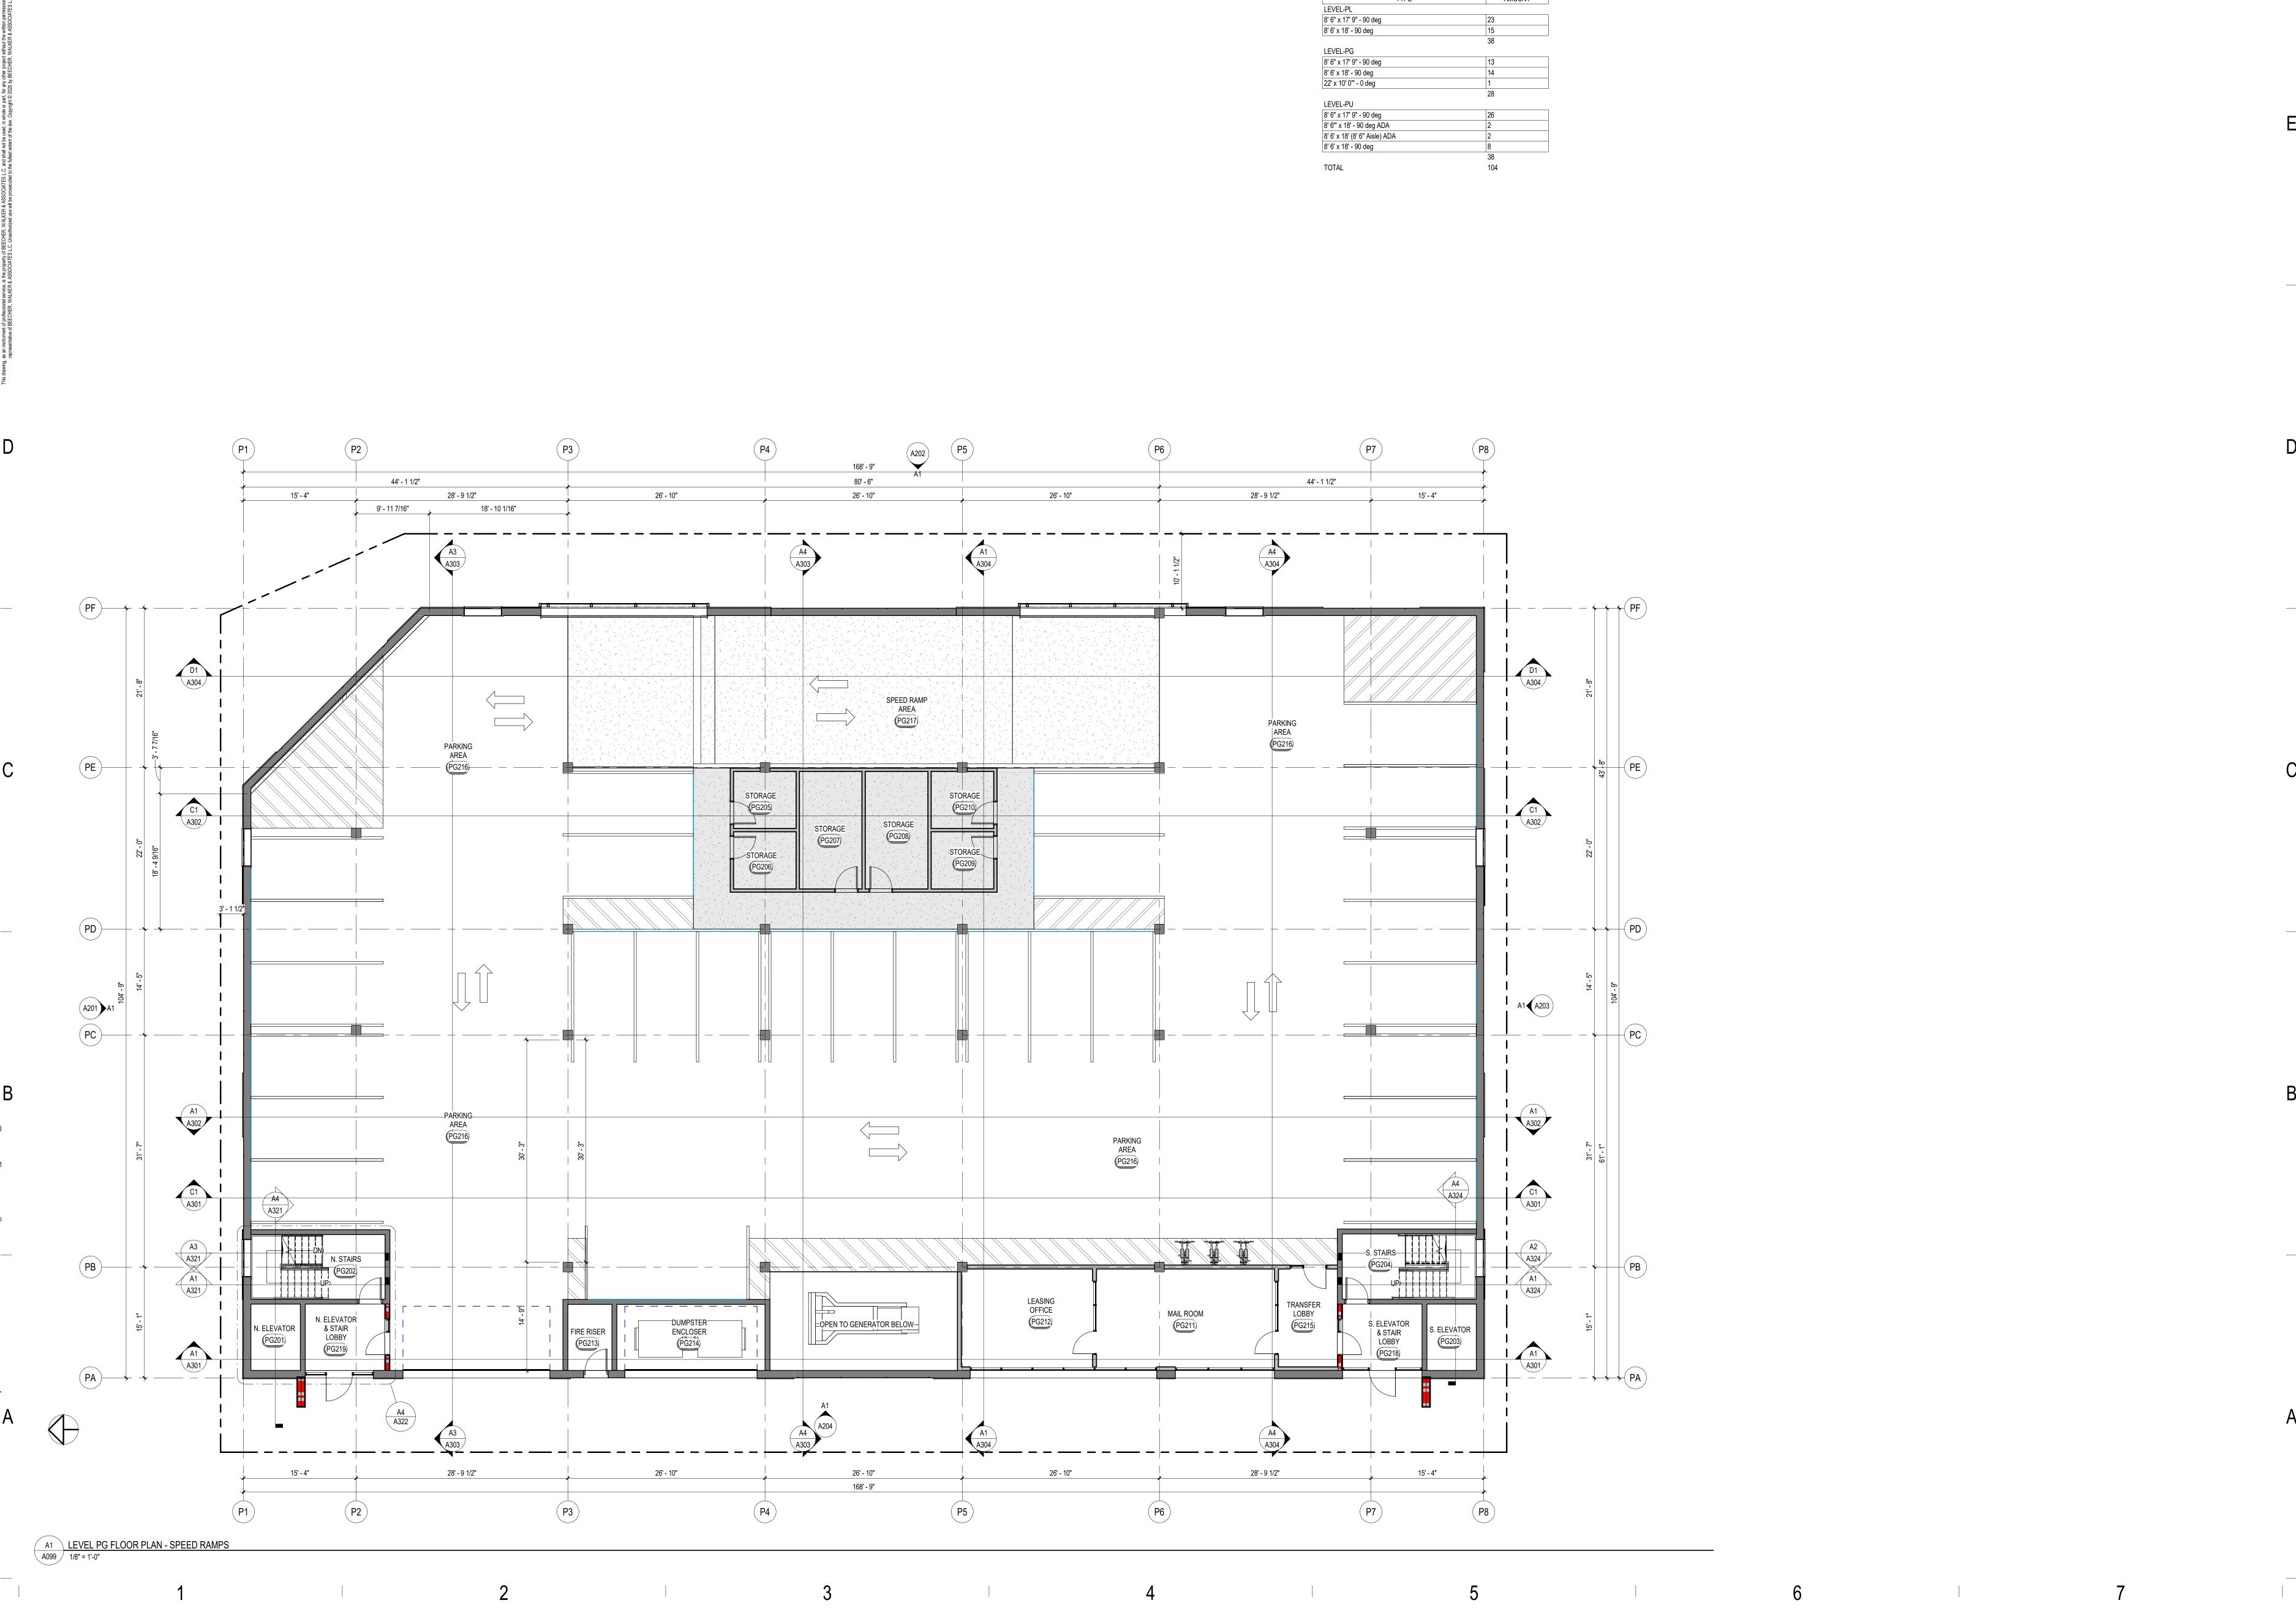

PARKING SCHEDULE - SPEED RAMPS

AMOUNT

MARK ISSUE DESCRIPTION ISS. DATE # REV. DESCRIPTION REV. DATE
SD SCHEMATIC DESIGN 06.03.2020
2 SITE PLAN REVIEW 8-11-2020

D

OHI APARMENTS
7 SOUTH 400 WEST
ALT LAKE CITY, UTAH 84101

Architecture/Interiors

O. 801.438.9500 | 3115 EAST LION LANE, #200 | BEECHERWALKER.COM
f. 801.438.9501 | HOLLADAY, UTAH 84121 |

DRAWING NUM

LEVEL PG FLOOR PLAN

KEYNOTE LEGEND

A CENERAL NOTES ARRIVED ALL DRAWINGS

A. GENERAL NOTES APPLY TO ALL DRAWINGS.
 B. ALL DIMENSIONS ARE EXTERIOR WALL TO FACE OF EXTERIOR STRUCTURAL SHEATHING, INTERIOR WALL STUD CENTER LINE, FACE OF MASONRY AND CONCRETE OR CENTER LINE OF COLUMNS UNLESS OTHERWISE NOTED.

C. EXTERIOR GRIDS ARE FACE OF CONCRETE OR EXTERIOR WALL STRUCTURAL SHEATHING UNLESS OTHERWISED NOTED.
 D. INTERIOR GRIDS AT DEMISING WALLS ARE CENTER LINE OF WALL STUD UNLESS OTHERWISE

NOTED

E. INTERIOR GRIDS AT CORRIDOR ARE ON STUD FACE; CORRIDOR SIDE OF WALL

F. DO NOT SCALE DRAWINGS.
G. CONTRACTOR IS RESPONSIBLE FOR FIELD VERIFICATION OF ALL DIMENSIONS AND FIELD CONDITIONS PRIOR TO ORDERING OR INSTALLING MATERIALS OR EQUIPMENT.
H. ELECTRICAL PLANS INDICATE THE GENERAL DESIGN AND ARRANGEMENT OF PIPES, CONDUIT, WIRING, EQUIPMENT, SYSTEMS, ETC... INFORMATION SHOWN IS DIAGRAMMATIC IN CHARACTER AND DOES NOT NECESSARILY INDICATE EVERY REQUIRED OFFSET, FITTING AND EXISTING CONDITION WHEN APPLIES. LOCATION OF THESE ITEMS MAY BE ADJUSTED CONDITIONAL UPON THE SATISFACTORY COMPLIANCE WITH ALL OTHER REQUIREMENTS.
I. ALL MATERIALS FOR USE IN THIS PROJECT SHALL BE NEW AND UNUSED UNLESS NOTED

J. ALL WALL PENETRATIONS AT RATED WALL LOCATIONS REQUIRED FOR PIPES, CONDUIT, DUCTING, ETC... SHALL BE SEALED TO STOP PASSAGE OF FIRE AND/OR SMOKE WITH FIRE SAFING AND

APPROVED SEALANT.

K. ALL ASPECTS OF THE WORK AND ITEMS NOT SPECIFICALLY MENTIONED, BUT WHICH ARE NECESSARY TO MAKE A COMPLETE WORKING INSTALLATION, SHALL BE INCLUDED AND INDICATED IN THE CONTRACTORS BID.

L. THE GENERAL CONTRACTOR AND ALL SUBCONTRACTORS ARE RESPONSIBLE FOR PROPER REMOVAL AND DISPOSAL OF ALL DEBRIS GENERATED BY CONSTRUCTION OF THIS PROJECT. THE

FEDERAL, STATE, AND LOCAL REGULATIONS. THE PREMISES SHALL BE KEPT CLEAN AND FREE FROM ALL WASTE MATERIALS.

M. GENERAL CONTRACTOR SHALL PROTECT NEW CONSTRUCTION FROM DAMAGE BY ALL TRADES. ALL SUCH DAMAGE CAUSED BY THE CONTRACTORS AND SUBCONTRACTORS DURING THE COURSE OF THIS WORK SHALL BE REPAIRED OR REPLACED AT THE CONTRACTORS EXPENSE.

N. ALL PIPING AND CONDUITS SHALL BE CONCEALED WITHIN WALLS, UNDERGROUND, ABOVE CEILING OR IN ARCHITECTS APPROVED UTILITY SPACES IN ALL CASES UNLESS NOTED THERWISE ON THE

REMOVAL AND DISPOSAL OF ALL CONSTRUCTION DEBRIS SHALL BE IN FULL COMPLIANCE WITH ALL

EXPOSED ITEMS ARE TO BE PAINTED TO MATCH THE ADJACENT SURFACES UNLESS SCHEDULED FOR AN ACCENT COLOR

O. ARCHITECTURAL FINISH FLOOR ELEVATION 100'-0" EQUALS ACTUAL SITE REFERENCE OF FINISH

DRAWINGS. EXPOSED ITEMS MUST BE LOCATED IN AREAS APPROVED BY THE ARCHITECT.

EXPOSED ITEMS SHALL BE INSTALLED AND FINISHED TO PROVIDE MINIMAL VISUAL IMPACT. ALL

FLOOR.
P. SEE SHEET A610 FOR WALL TYPES.
Q. SEE SHEET A601 FOR DOOR AND WINDOW TYPES.

R. SEE DETAIL B5/A541 FOR FIRE EXTINGUISHER CABINET.
 S. FIREBLOCKING SHALL BE INSTALLED TO CUT OFF CONCEALED DRAFT OPENINGS (BOTH VERTICAL AND HORIZONTAL) AND SHALL FORM AN EFFECTIVE BARRIER BETWEEN FLOORS, BETWEEN A TOP STORY AND A ROOF OR ATTIC SPACE.

T. FIREBLOCKING SHALL CONSIST OF 2-INCH NOMINAL LUMBER OR TWO THICKNESSES OF 1-INCH NOMINAL LUMBER WITH BROKEN LAP JOINTS OR ONE THICKNESS OF 0.719-INCH WOOD STRUCTURAL PANEL WITH JOINTS BACKED BY 0.719-INCH WOOD STRUCTURAL PANEL OF ONE THICKNESS OF 0.75-INCH PARTICLEBOARD WITH JOINTS BACKED BY 0.75-INCH PARTICLEBOARD. GYPSUM BOARD, CEMENT FIBER BOARD, BATTS OR BLANKETS OF MINERAL WOOL, GLASS FIBER OR OTHER APPROVED MATERIALS INSTALLED IN SUCH A MANNNER AS TO BE SECURELY RETAINED IN PLACE SHALL BE PERMITTED AS AN ACCEPTABLE FIREBLOCK.
 U. FIREBLOCKING SHALL BE PROVIDED IN CONCEALED SPACES OF STUD WALLS AND PARTITIONS, INCLUDING FURRED SPACES, AND PARALLEL ROWS OF STUDS OR STAGGERED STUDS, AS

FOLLOWS:
1. VERTICALLY AT THE CEILING AND FLOOR LEVELS.

HORIZONTALLY AT INTERVALS NOT EXCEEDING 10'.
 FIREBLOCKING SHALL BE PROVDED AT INTERCONNECTIONS BETWEEN CONCEALED VERTICAL
STUD WALL OR PARTITION SPACES AND CONCEALED HORIZONTAL SPACES CREATED BY AN
ASSEMBLY OF FLOOR JOISTS OR TRUSSES, AND BETWEEN CONCEALED VERTICAL AND
HORIZONTAL SPACES SUCH AS OCCUR AT SOFFITS, DROP CEILINGS, COVE CEILINGS AND SIMILAR

W. FIREBLOCKING SHALL BE INSTALLED AT OPENINGS AROUND VENTS PIPES, DUCTS CHIMNEYS AND FIREPLACES AT CEILING AND FLOOR LEVELS, WITH AN APPROVED MATERIAL TO RESIST THE FREE PASSAGE OF FLAME AND THE PRODUCTS OF COMBUSTION. FACTORY-BUILT CHIMNEYS AND FIREPLACES SHALL BE FIREBLOCKED IN ACCORADANCE WITH UL 103 AND UL 127.

X. DRAFTSTOPPING - IN COMBUSTIBLE CONSTRUCTION, DRAFTSTOPPING SHALL BE INSTALLED TO

SUBDIVIDE FLOOR/CEILING ASSEMBLIES.

Y. DRAFTSTOPPING MATERIALS SHALL NOT BE LESS THAN 0.5-INCH GYPSUM BOARD, 0.375-INCH WOOD STRUCTUAL PANEL, 0.375-INCH PARTICLEBOARD, 1-INCH NOMINAL LUMBER, CEMENT FIBERBOARD, BBATTS, OR BLANKETS OF MINERAL WOOL OR GLASS FIBER OR OTHER APPROVED MATERIALS ADEQUATELY SUPPORTED. THE INTEGRITY OF DRAFTSTOPS SHALL BE MAINTAINED.

Z. DRAFTSTOPPING SHALL BE PROVIDED IN FLOOR/CEILING SPACES. DRAFTSTOPPING SHALL BE LOCATED ABOVE AND IN LINE WITH THE DWELLING UNIT AND SLEEPING UNIT SEPARATIONS.

AA. DRAFTSTOPPING - IN COMBUSTIBLE CONSTRUCTION, DRAFTSTOPPING SHALL BE INSTALLED TO SUBDIVIDE THE ATTIC SPACES AND CONCEALED ROOF SPACES. VENTILATION OF CONCEALED ROOF SPACES SHALL BE MAINTAINED IN ACCORDANCE WITH THE 2018 IBC.
 BB. DRAFTSTOPPING - OPENINGS IN THE PARTITIONS SHALL BE PROTECTED BY SELF-CLOSING DOORS WITH AUTOMATIC LATCHES CONSTRUCTED AS REQUIRED FOR THE PARTITIONS.
 CC. ZDRAFTSTOPPING SHALL BE INSTALLED ABOVE, AND INLINE WITH, SLEEPING UNIT AND DWELLING

UNIT SEPERATION WALLS THAT DO NOT EXTEND TO THE UNDERSIDE OF THE ROOF SHEATHING ABOVE.

DD. ADRAFTSTOPS MUST BE PLACED INTO AREAS NOT EXCEEDING 3,000 SQUARE FEET OR ABOVE EVERY TWO DWELLING UNITS, WHICHEVER IS SMALLER.

GG. APRE-ROCK RESTROOM WALLS AROUND TUBS AND SHOWERS LOCATED AS PER ENLARGED UNIT

EE. ALL SWITCHES, OUTLETS, AND CONTROLS ON ALL FLOORS ARE TO BE LOCATED PER ADA STANDARDS.

FF. IN ALL UNITS - REINFORCING & OR BLOCKING FOR GRAB BARS IN ALL RESTROOM WALLS AROUND TOILET, TUB, SHOWERS, ETC. ARE TO BE LOCATED AS PER ENLARGED UNIT SHEETS.

HH. ALL DWELLING UNITS ARE TO BE ACCESSIBLE AS REQUIRED BY ANSI A117.1-2017 (SEE SHEET G002).

2% WILL BE TYPE "A" UNITS THE REMAINING WILL BE TYPE "B" UNITS.

II. ALL EXTERIOR BALCONIES ARE NOT RATED, BUT WILL BE PROVIDED WITH SPRINKLER PROTECTION TO THOSE AREAS AS DIRECTED BY IBC 1406.3 EXCEPTION 3.

JJ. FIRE DEPARTMENT STANDPIPE EQUIPMENT IS NOT TO ENCROACH INTO THE STAIR LANDING BEYOND THE RADIUS EXTENDING FROM THE INSIDE CORNER OF THE REQUIRED STAIR LANDING WIDTH.

KK. DRYER/EXHAUST VENTS TO BE LOCATED AWAY FROM ANY OPERABLE WINDOWS/DOORS AS PER 2018 IMC.
 LL. MEMBERS OF THE PRIMARY STRUCTURAL FRAME OTHER THAN COLUMNS THAT ARE REQUIRED TO HAVE A FIRE-RESISTANCE RATING AND SUPPORT MORE THAN TWO FLOORS OR ONE FLOOR AND ONE ROOF, OR SUPPORT A LOAD-BEARING WALL OR A NONLOAD-BEARING WALL MORE THAN TWO.

ONE ROOF, OR SUPPORT A LOAD-BEARING WALL OR A NONLOAD-BEARING WALL MORE THAN TWO STORIES HIGH, SHALL BE PROVIDED INDIVIDUAL ENCASEMENT PROTECTION BY PROTECTING THEM ON ALL SIDES FOR THEIR FULL LENGTH, INCLUDING CONNECTIONS TO OTHER STRUCTURAL MEMBERS, WITH MATERIALS HAVING THE REQUIRED FIRE-RESISTANCE RATING.

FLOOR PLAN GENERAL NOTES:

A. GENERAL NOTES APPLY TO ALL DRAWINGS.

B. ALL DIMENSIONS ARE EXTERIOR WALL TO FACE OF STUD, INTERIOR WALL TO FACE OF GYPSUM BOARD, FACE OF MASONRY OR CENTER LINE OF COLUMNS UNLESS OTHERWISE NOTED.
C. DO NOT SCALE DRAWINGS.
D. CONTRACTOR IS RESPONSIBLE FOR FIELD VERIFICATION OF ALL DIMENSIONS AND FIELD

CONDITIONS PRIOR TO ORDERING OR INSTALLING MATERIALS OR EQUIPMENT.

E. ALL MATERIALS FOR USE IN THIS PROJECT SHALL BE NEW AND UNUSED UNLESS NOTED OTHERWISE.

F. ALL WALL PENETRATIONS AT RATED WALL LOCATIONS REQUIRED FOR PIPES, CONDUIT, DUCTING, ETC... SHALL BE SEALED TO STOP PASSAGE OF FIRE AND/OR SMOKE WITH FIRE SAFING AND APPROVED SEALANT.
G. ALL ASPECTS OF THE WORK AND ITEMS NOT SPECIFICALLY MENTIONED, BUT WHICH ARE NECESSARY TO MAKE A COMPLETE WORKING INSTALLATION, SHALL BE INCLUDED AND INDICATED

IN THE CONTRACTORS BID.

H. THE GENERAL CONTRACTOR AND ALL SUBCONTRACTORS ARE RESPONSIBLE FOR PROPER REMOVAL AND DISPOSAL OF ALL DEBRIS GENERATED BY CONSTRUCTION OF THIS PROJECT. THE REMOVAL AND DISPOSAL OF ALL CONSTRUCTION DEBRIS SHALL BE IN FULL COMPLIANCE WITH ALL FEDERAL, STATE, AND LOCAL REGULATIONS. THE PREMISES SHALL BE KEPT CLEAN AND FREE FROM ALL WASTE MATERIALS.

I. GENERAL CONTRACTOR SHALL PROTECT NEW CONSTRUCTION FROM DAMAGE BY ALL TRADES. ALL SUCH DAMAGE CAUSED BY THE CONTRACTORS AND SUBCONTRACTORS DURING THE COURSE

OF THIS WORK SHALL BE REPAIRED OR REPLACED AT THE CONTRACTORS EXPENSE.

J. ALL PIPING AND CONDUITS SHALL BE CONCEALED WITHIN WALLS, UNDERGROUND, ABOVE CEILING OR IN ARCHITECTS APPROVED UTILITY SPACES IN ALL CASES UNLESS NOTED THERWISE ON THE DRAWINGS. EXPOSED ITEMS MUST BE LOCATED IN AREAS APPROVED BY THE ARCHITECT. EXPOSED ITEMS SHALL BE INSTALLED AND FINISHED TO PROVIDE MINIMAL VISUAL IMPACT. ALL EXPOSED ITEMS ARE TO BE PAINTED TO MATCH THE ADJACENT SURFACES UNLESS SCHEDULED FOR AN ACCENT COLOR

FOR AN ACCENT COLOR
K. ARCHITECTURAL FINISH FLOOR ELEVATION OF 100'-0" EQUALS ACTUAL SITE REFERENCE OF FINISH FLOOR ON CIVIL DRAWINGS.
L. SEE SHEET A610 FOR WALL TYPES.

M. SEE SHEET A601 FOR DOOR AND WINDOW TYPE ELEVATIONS.
 N. MEMBERS OF THE PRIMARY STRUCTURAL FRAME OTHER THAN COLUMNS THAT ARE REQUIRED TO HAVE A FIRE-RESISTANCE RATING AND SUPPORT MORE THAN TWO FLOORS OR ONE FLOOR AND ONE ROOF, OR SUPPORT A LOAD-BEARING WALL OR A NONLOAD-BEARING WALL MORE THAN TWO STORIES HIGH, SHALL BE PROVIDED INDIVIDUAL ENCASEMENT PROTECTION BY PROTECTING THEM ON ALL SIDES FOR THEIR FULL LENGTH, INCLUDING CONNECTIONS TO OTHER STRUCTURAL MEMBERS, WITH MATERIALS HAVING THE REQUIRED FIRE-RESISTANCE RATING, SEE SHEET G003.

O. GENERAL CONTRACTOR SHALL COORDINATE THE SIZE, THICKNESS AND LOCATION OF CONCRETE HOUSEKEEPING PADS WITH MECHANICAL AND ELECTRICAL EQUIPMENT SUPPLIERS.
P. FIREBLOCKING SHALL BE INSTALLED AT OPENINGS AROUND VENT PIPES AND DUCTS AT CEILING AND FLOOR LEVELS WITH AN APPROVED MATERIAL TO RESIST THE FREE PASSAGE OF FLAME AND THE PRODUCTS OF COMBUSTION.

MARK ISSUE DESCRIPTION ISS. DATE #
SD SCHEMATIC DESIGN 06.03.2020
2 SITE PLAN REVIEW 8-11-2020

SOHI APARMENTS 27 SOUTH 400 WEST ALT LAKE CITY, UTAH 84101

Architecture/Interiors
801.438.9500 3115 EAST LION LANE, #200 BEECHERWALKER.COM
HOLLADAY, UTAH 84121


PROJECT NUMBER
462.1905


DWN BY CHKD

SITE PLAN REVII


LEVEL PU FLOOR


A10C

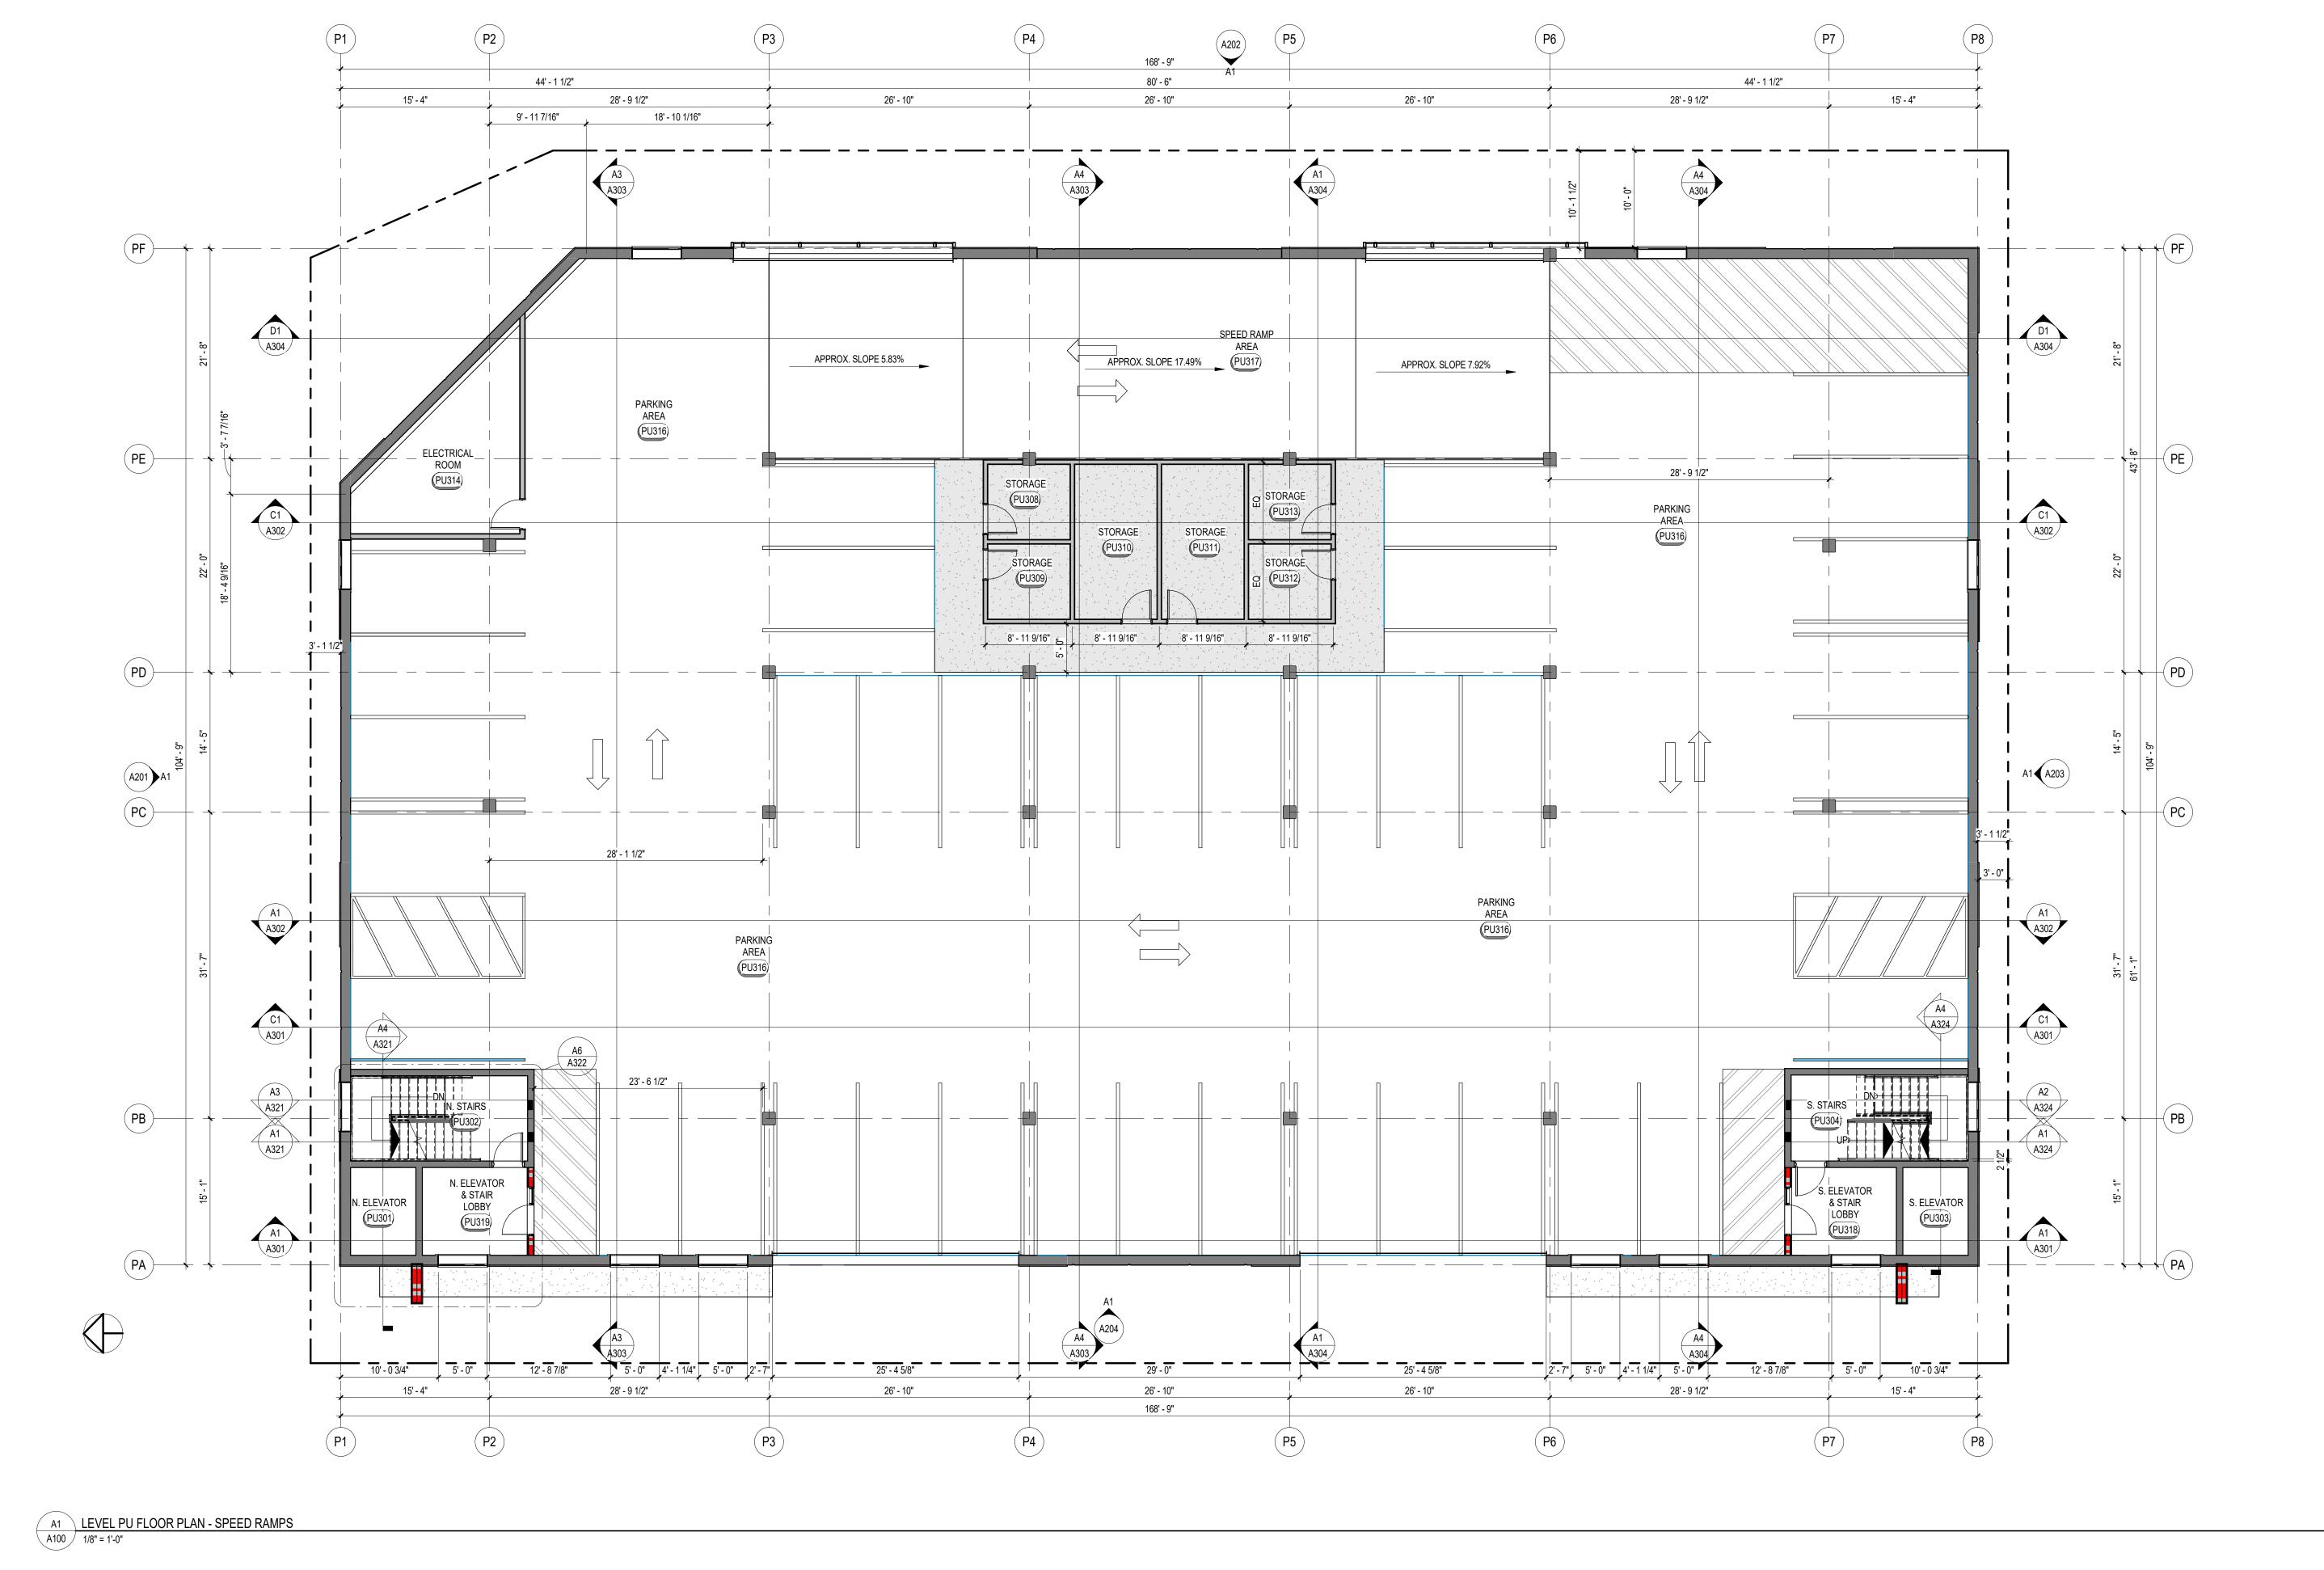


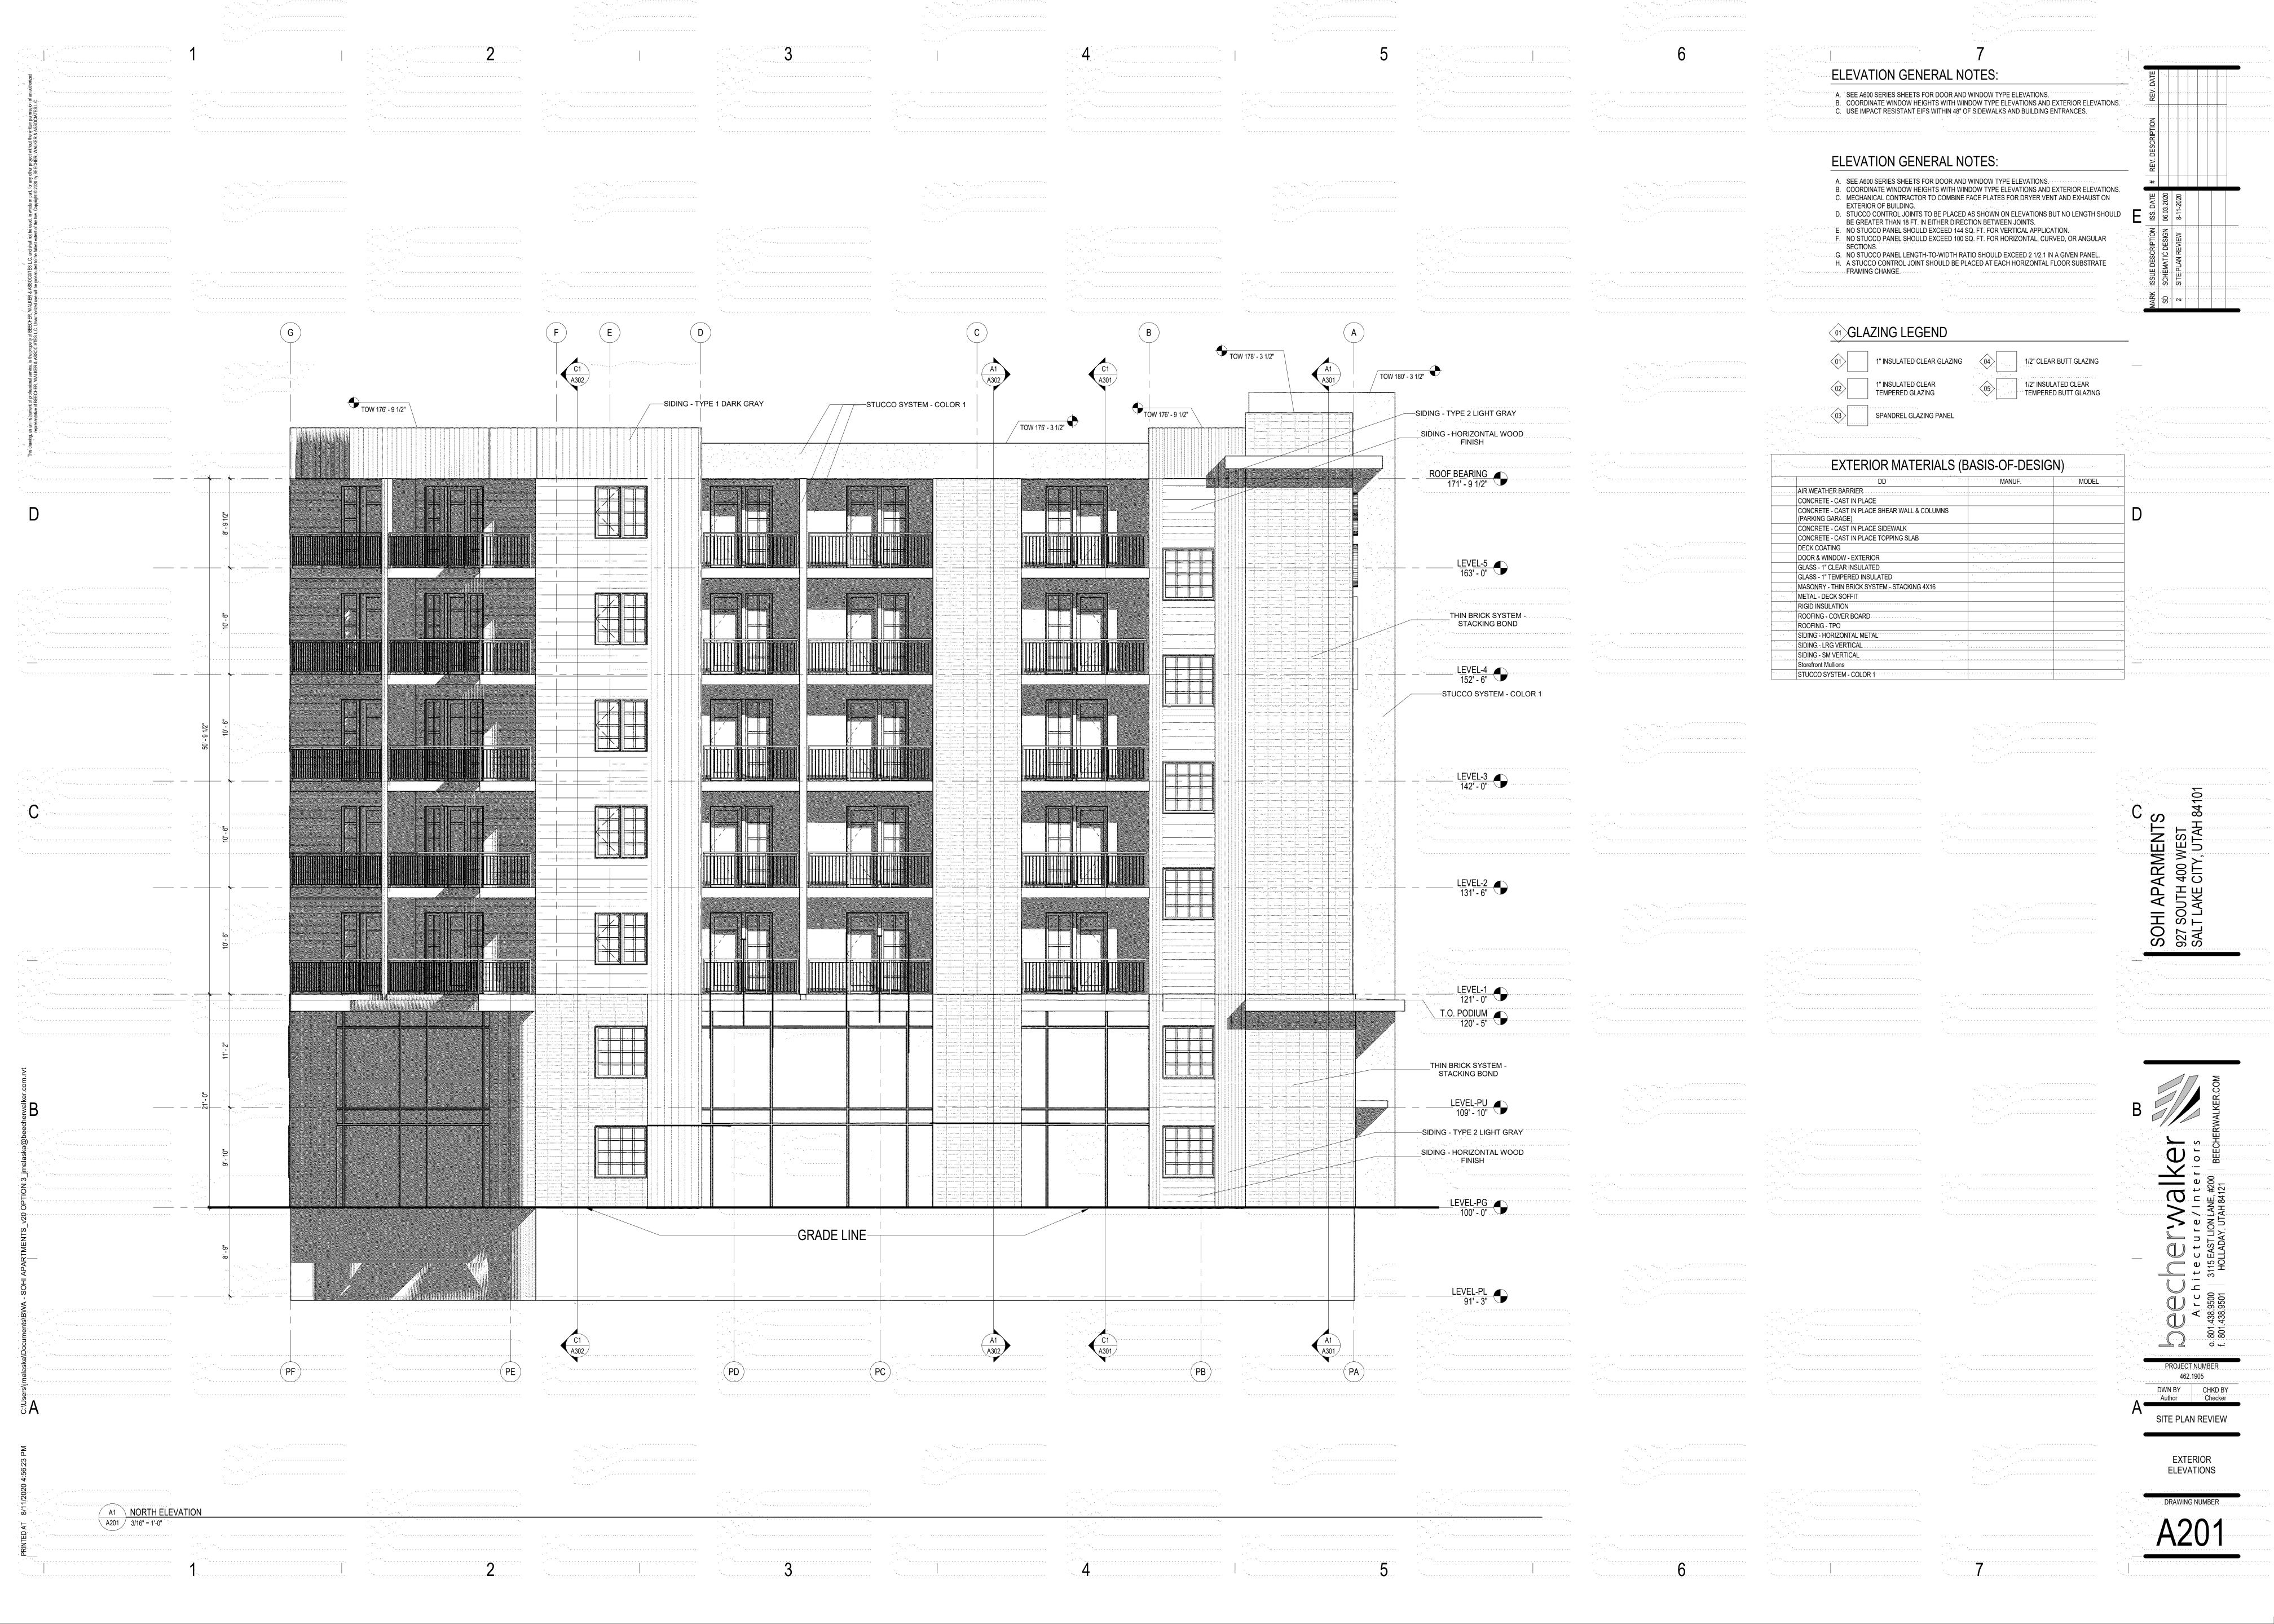




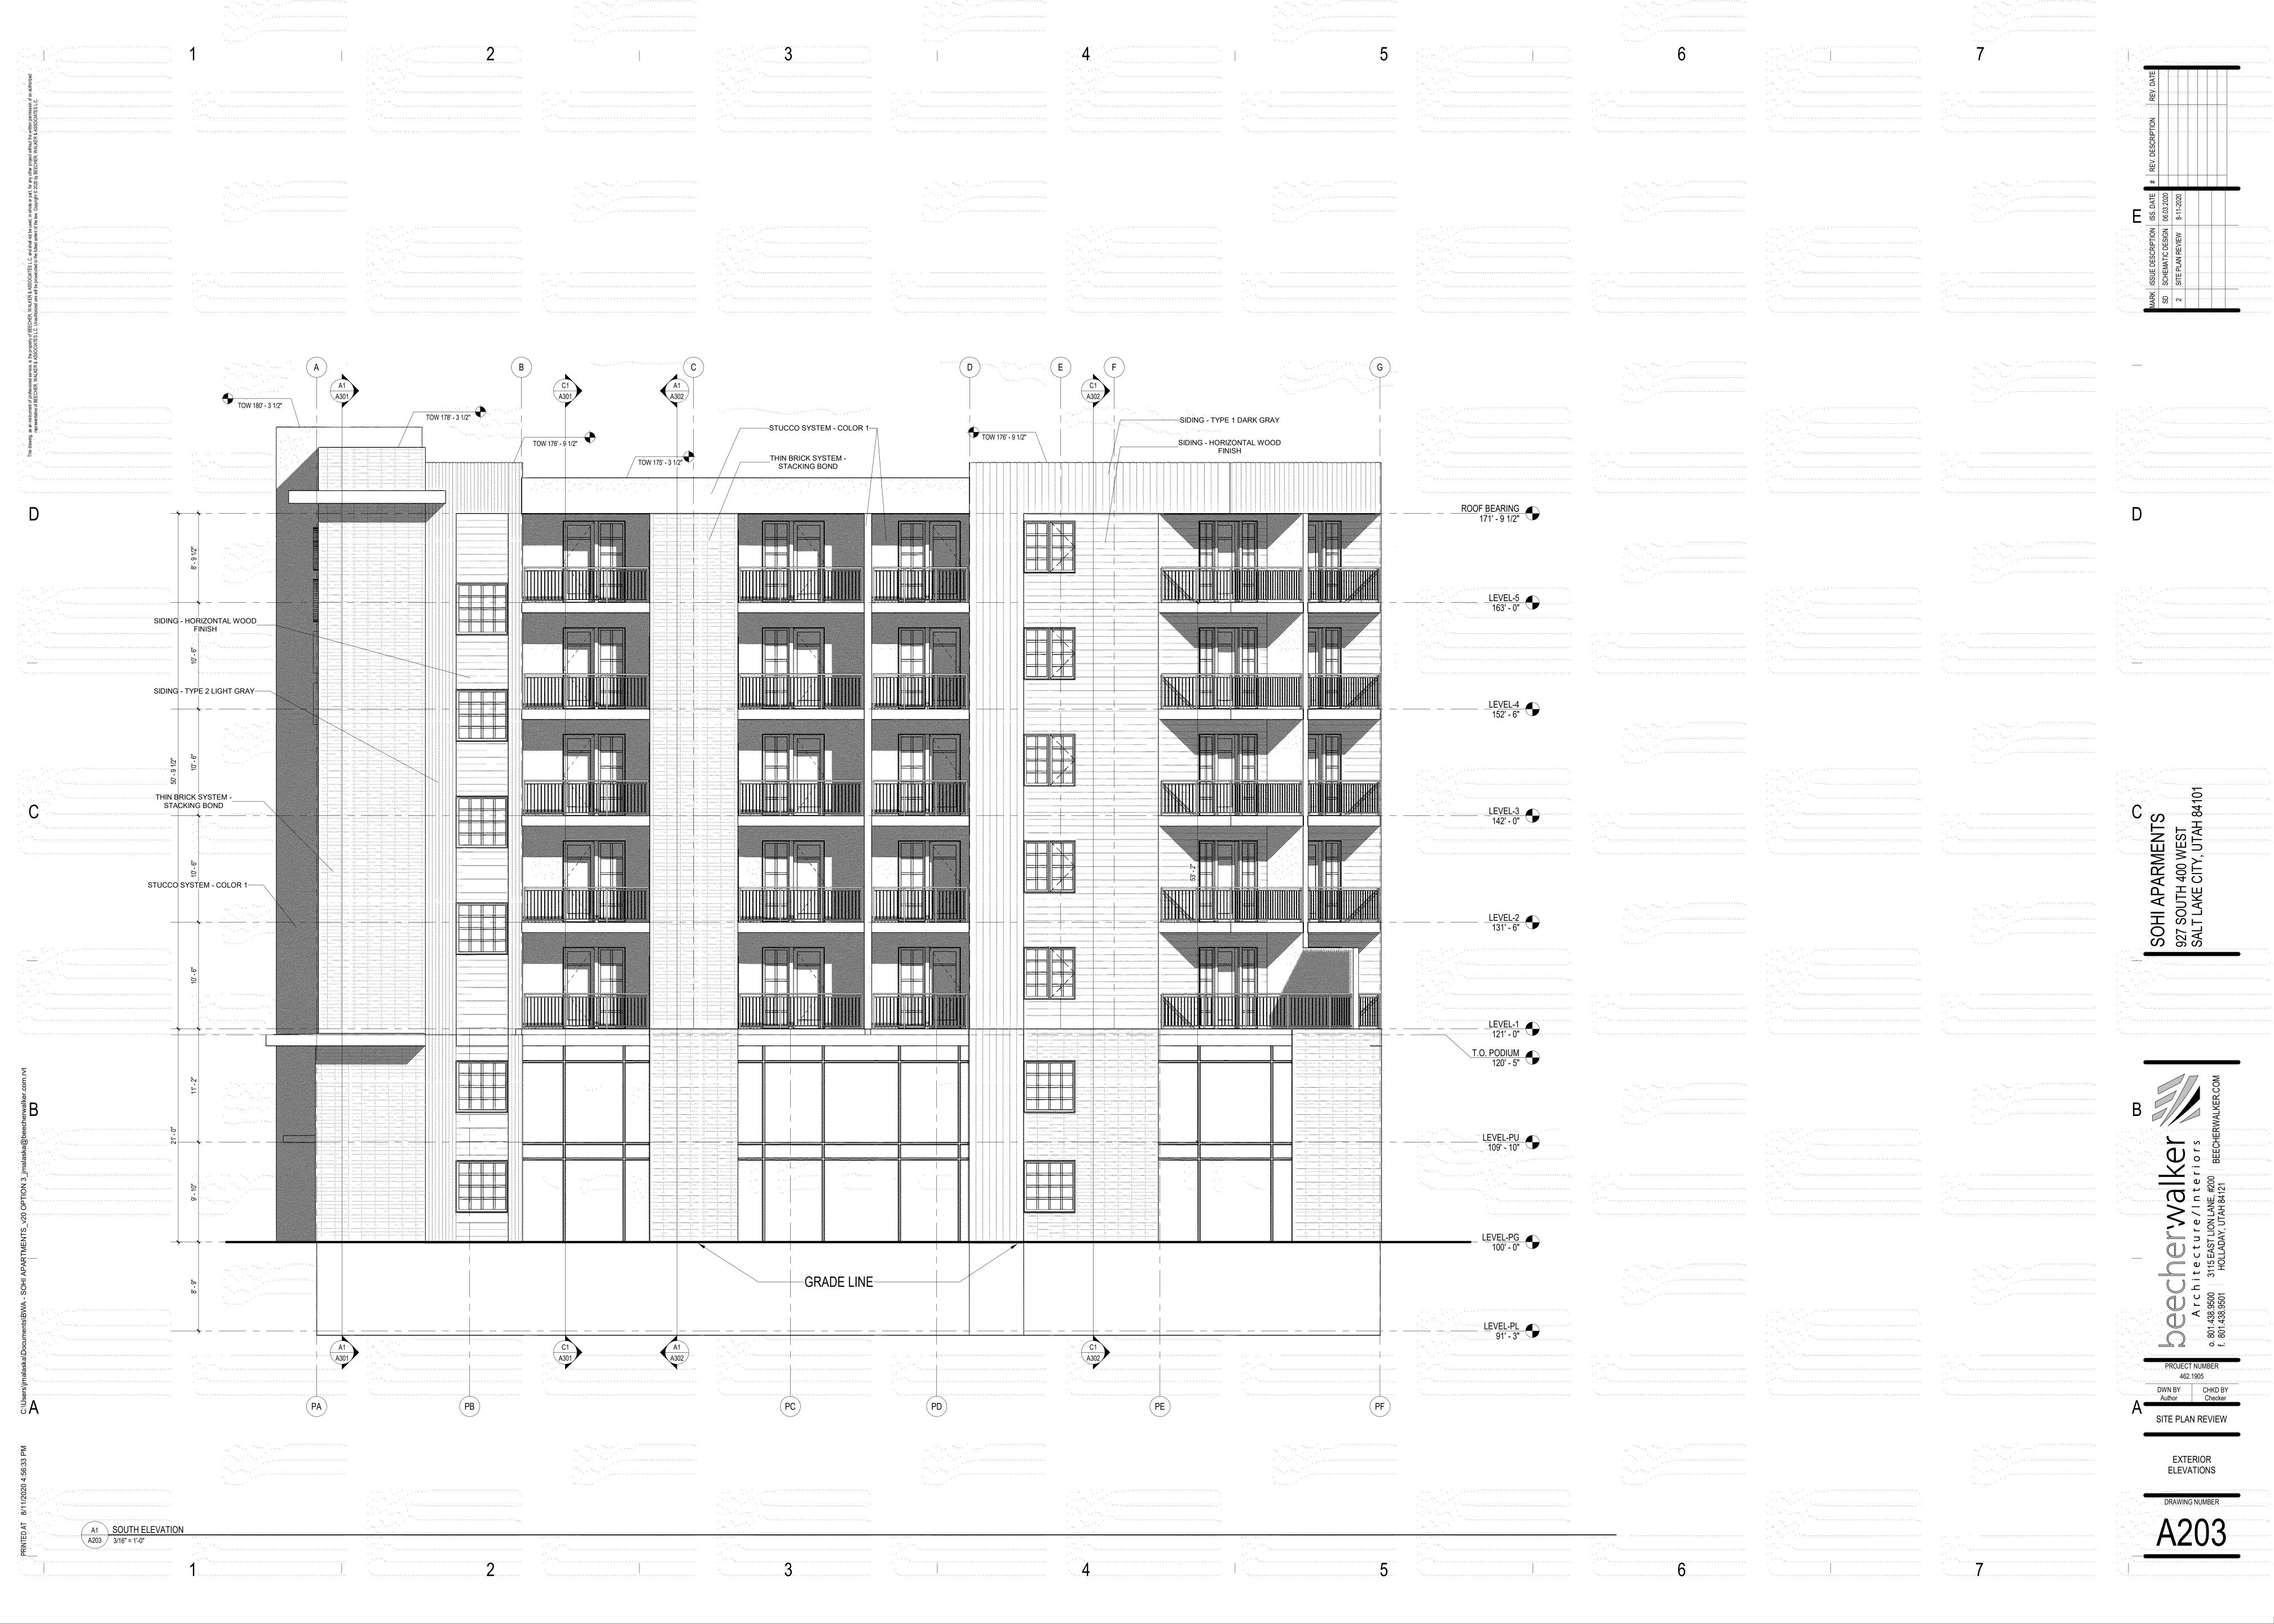

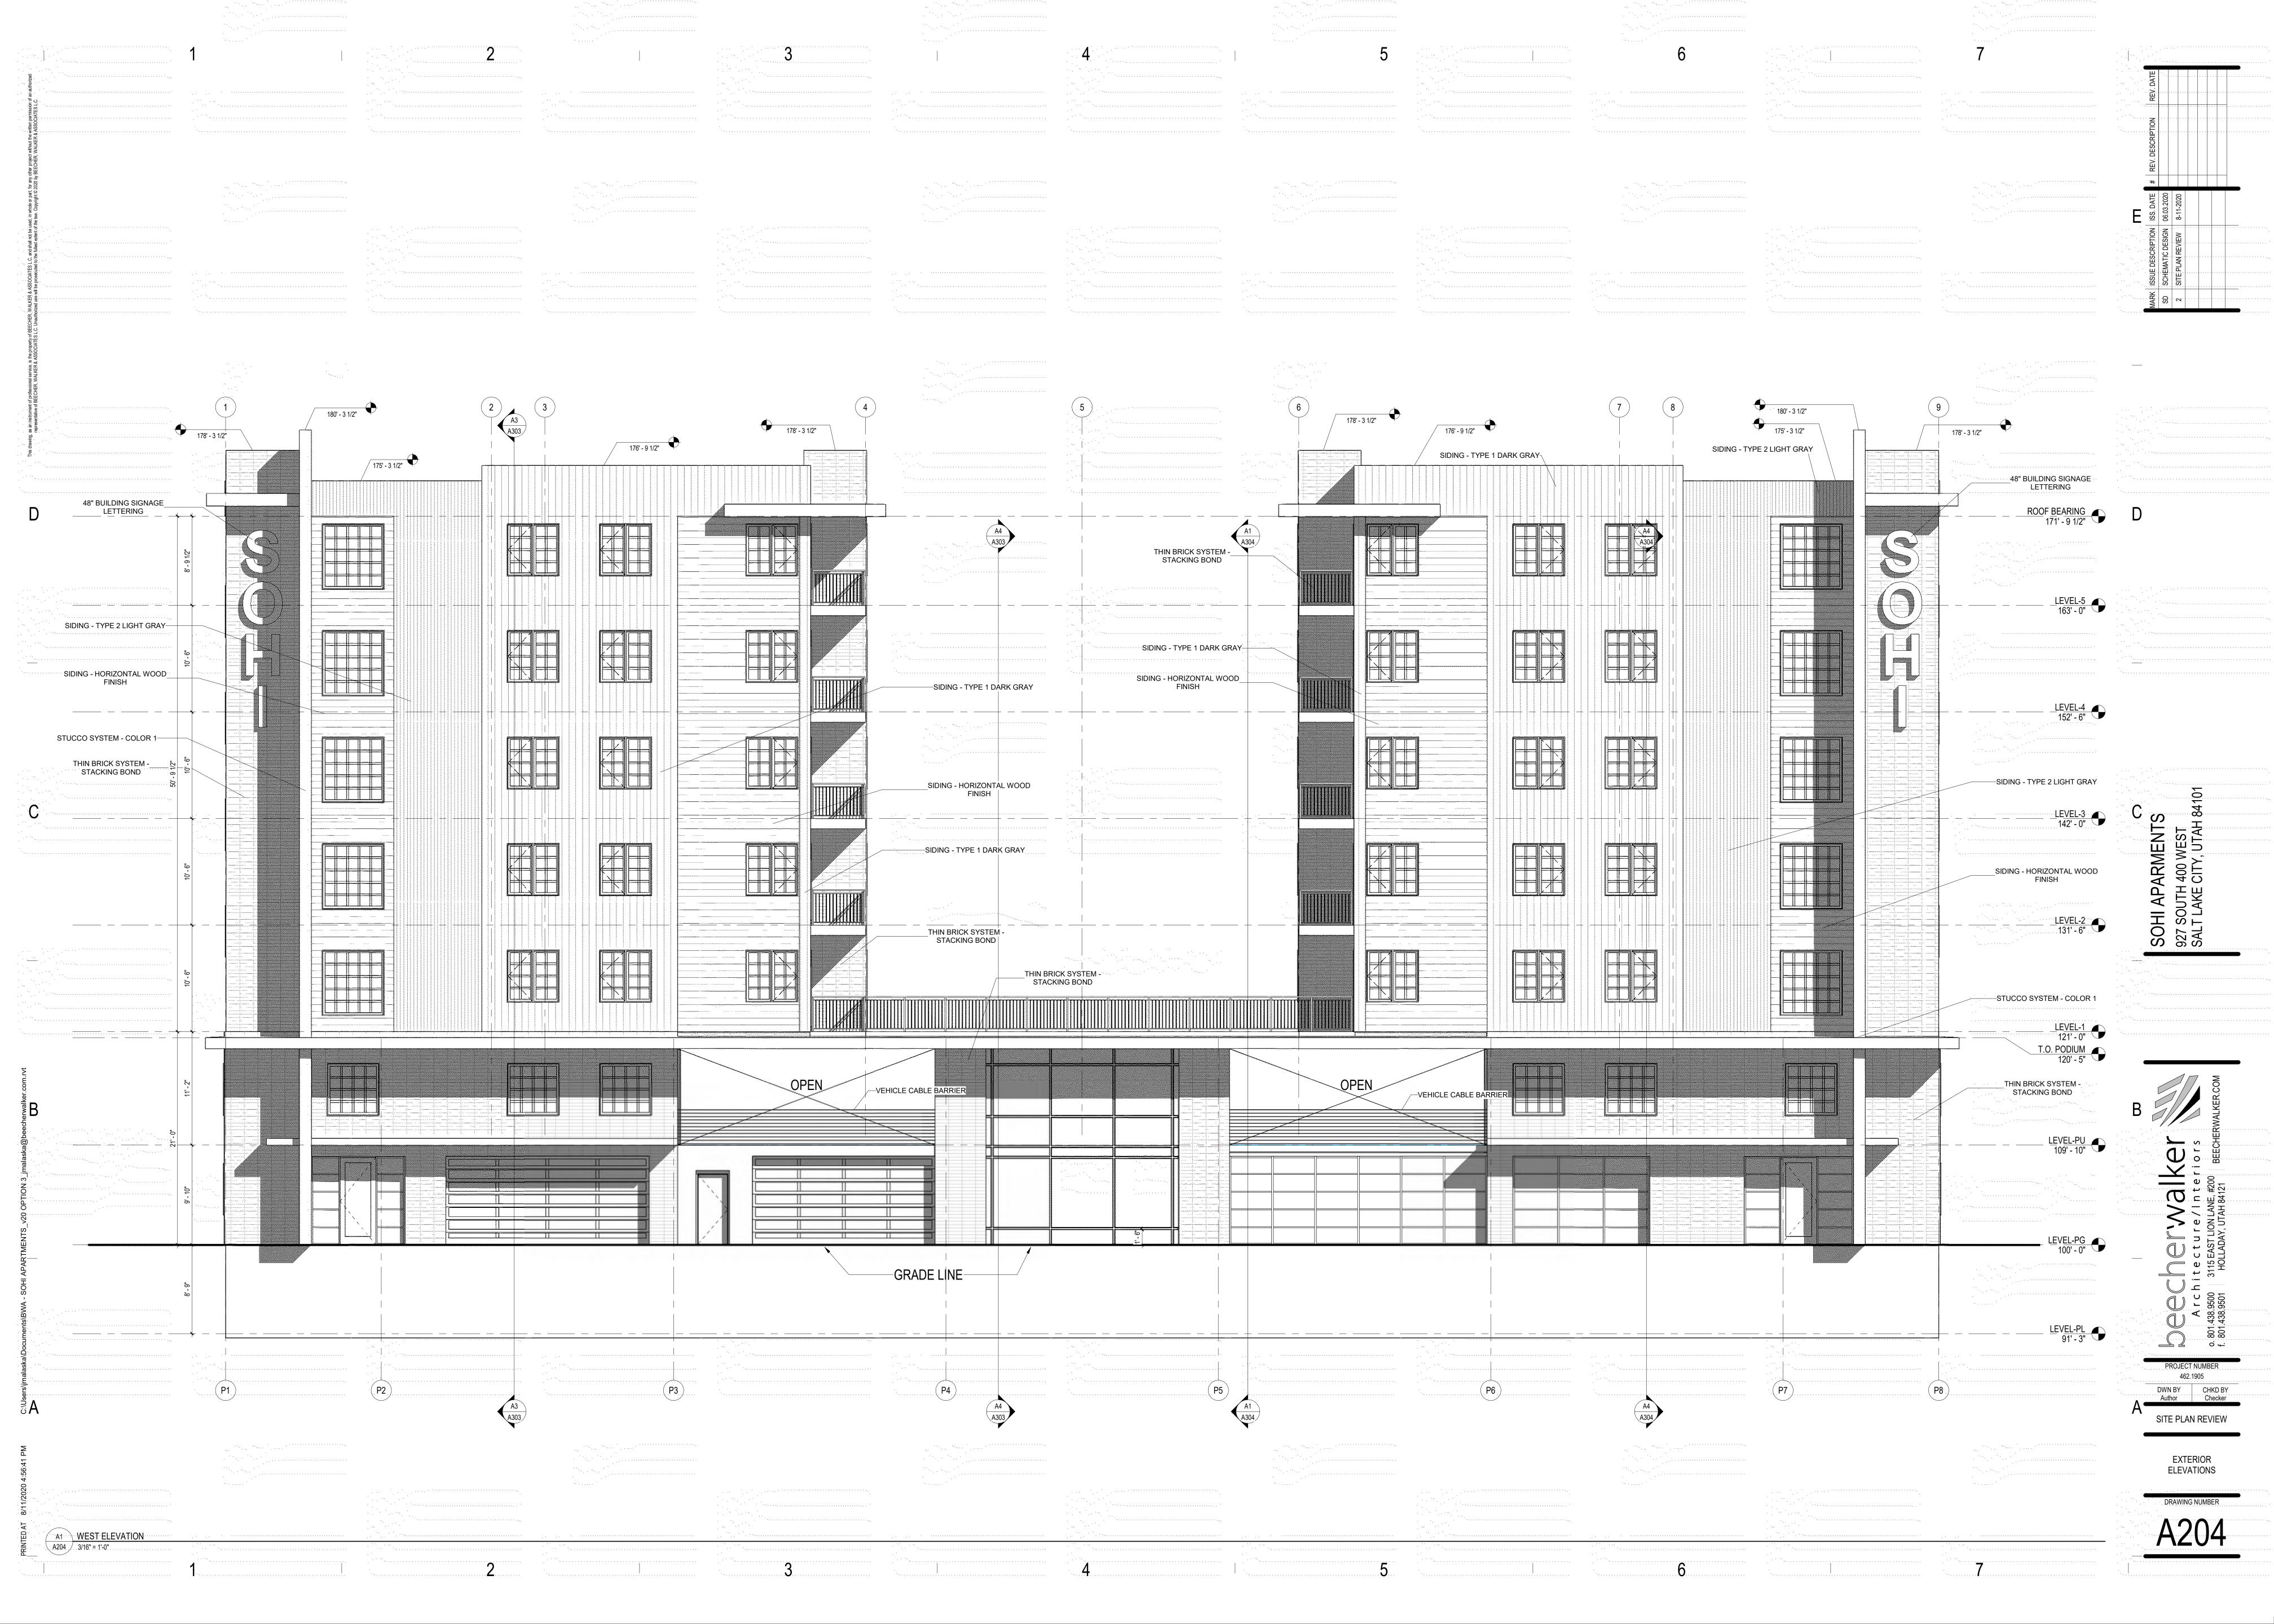

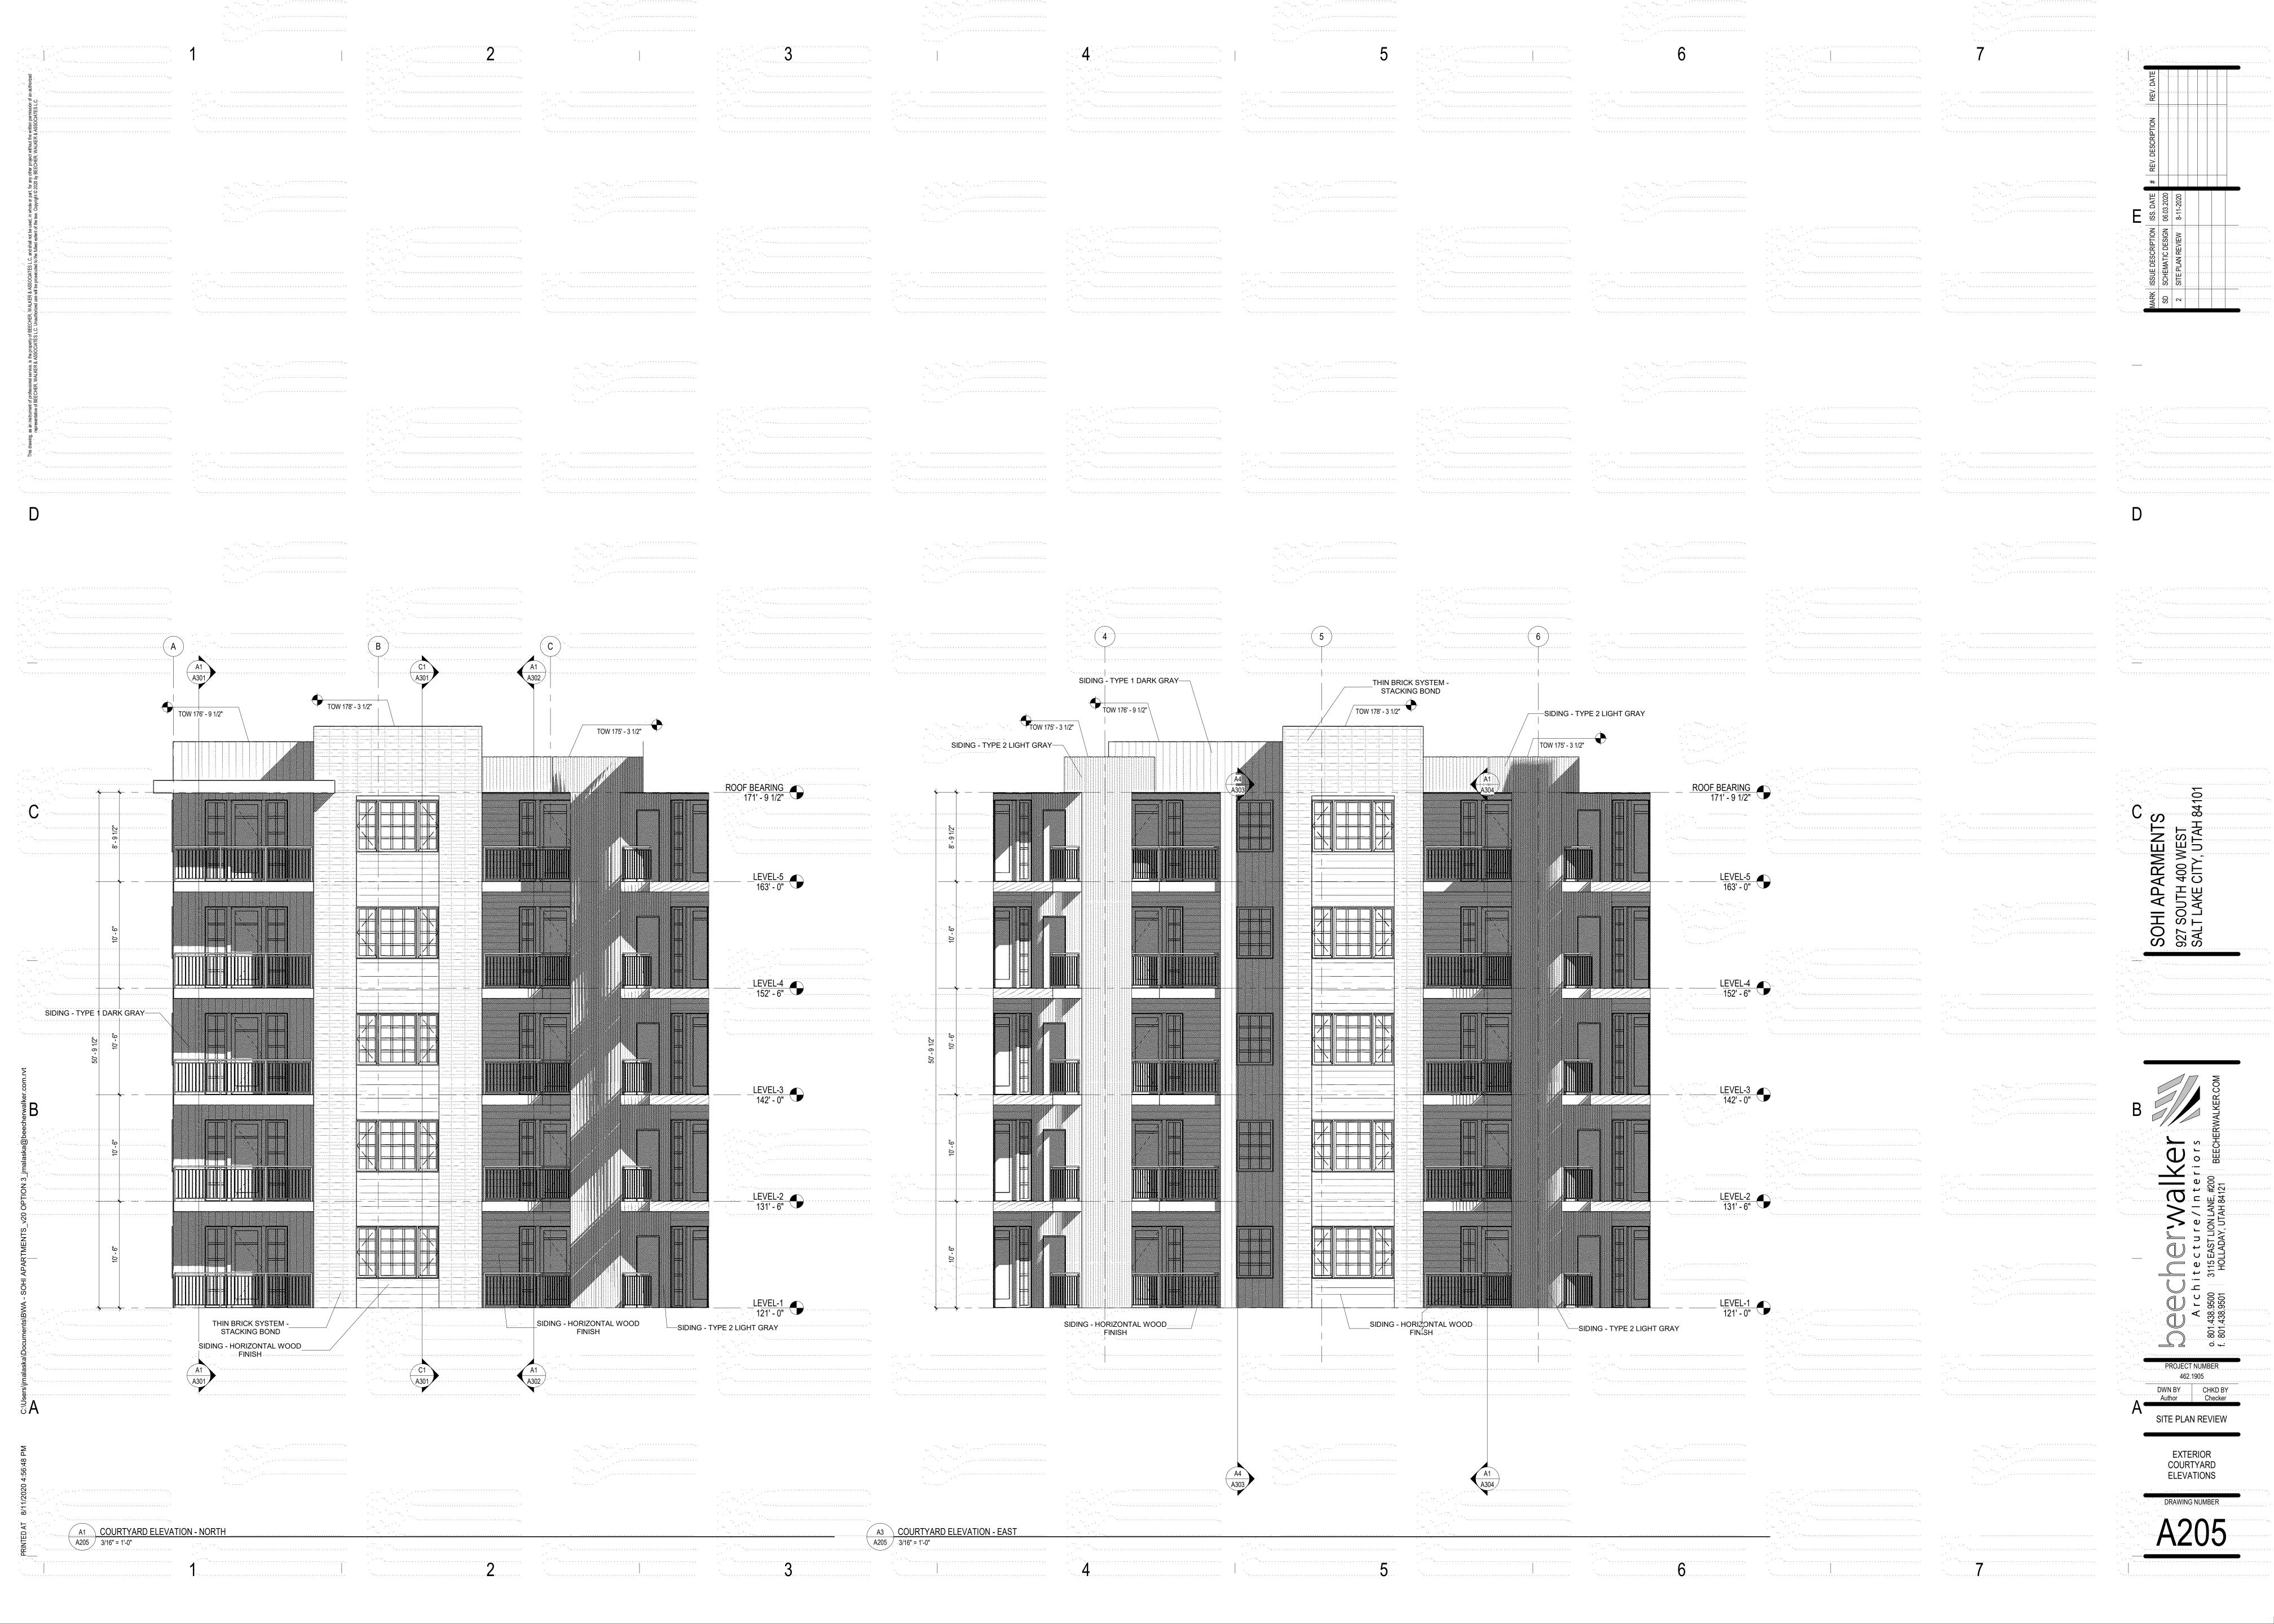

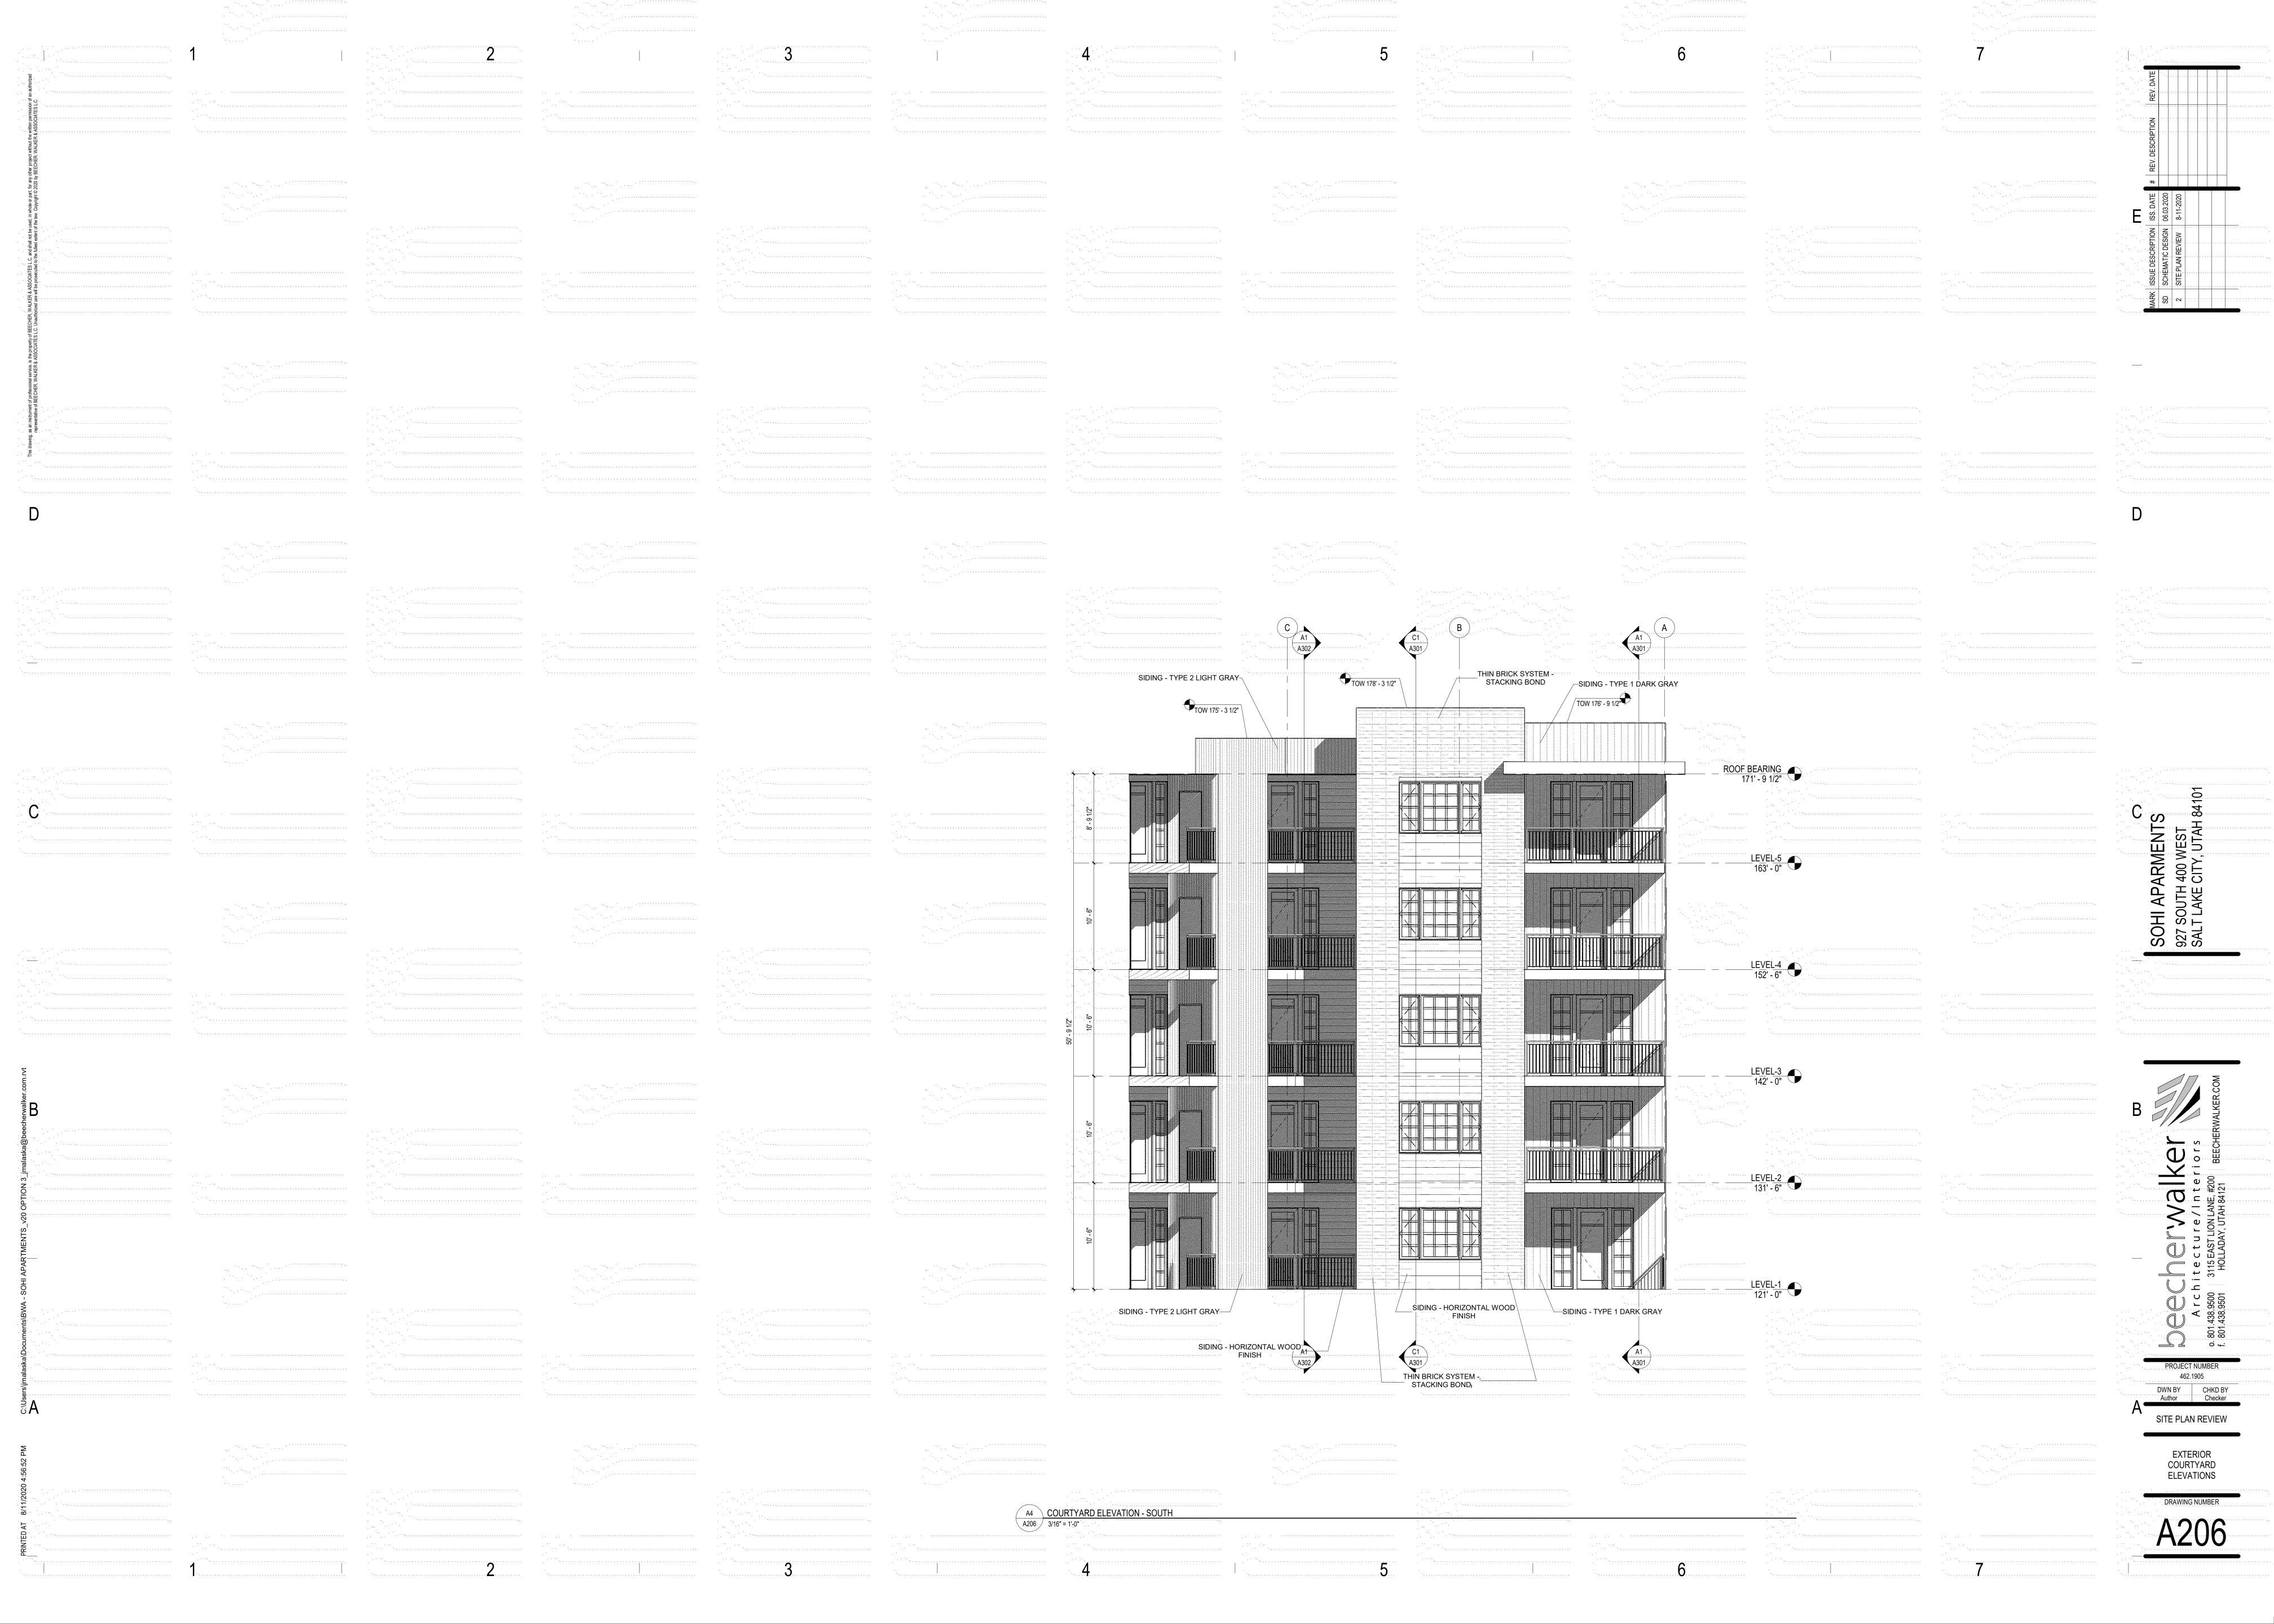



SECTION GENERAL NOTES:


A. CLASS "B" ROOF FIRE CLASSIFICATION FOR ROOF MEMBRANE.B. STC (SOUND TRANSMISSION CLASS) RATING FOR TRANSMISSION OF AIR BORN NOISE THROUGH WALLS, CEILING/FLOOR ASSEMBLIES AND PUBLIC SPACES ARE TO BE 50 STC MINIMUM.

C. IIC (IMPACT ISOLATION CLASS) RATING FOR TRANSMISSION OF STRUCTURE BORN NOISE BETWEEN DEWLLINGS AND FLOOR/CEILING ASSEMBLIES TO BE 50 IIC MINIMUM. D. CONTRACTOR TO PROVIDE ATTIC VENTILATION WITH A NET FREE VENTILATING AREA NOT TO BE LESS THAN 1/150 OF THE SPACE VENTILATED, WITH 50% OF THE REQUIRED VENTILATING AREA

REQUIRED VENTILATION PROVIDED BY THE EAVE AND/OR CORNICE VENTS.

PROVIDED BY VENTILATORS LOCATED IN THE UPPER PORTION OF THE SPACE. THE SPACE MUST BE VENTILATED LEAST 3 FEET ABOVE THE EAVE OR CORNICE VENTS WITH THE BALANCE OF THE

BUILDING SECTIONS

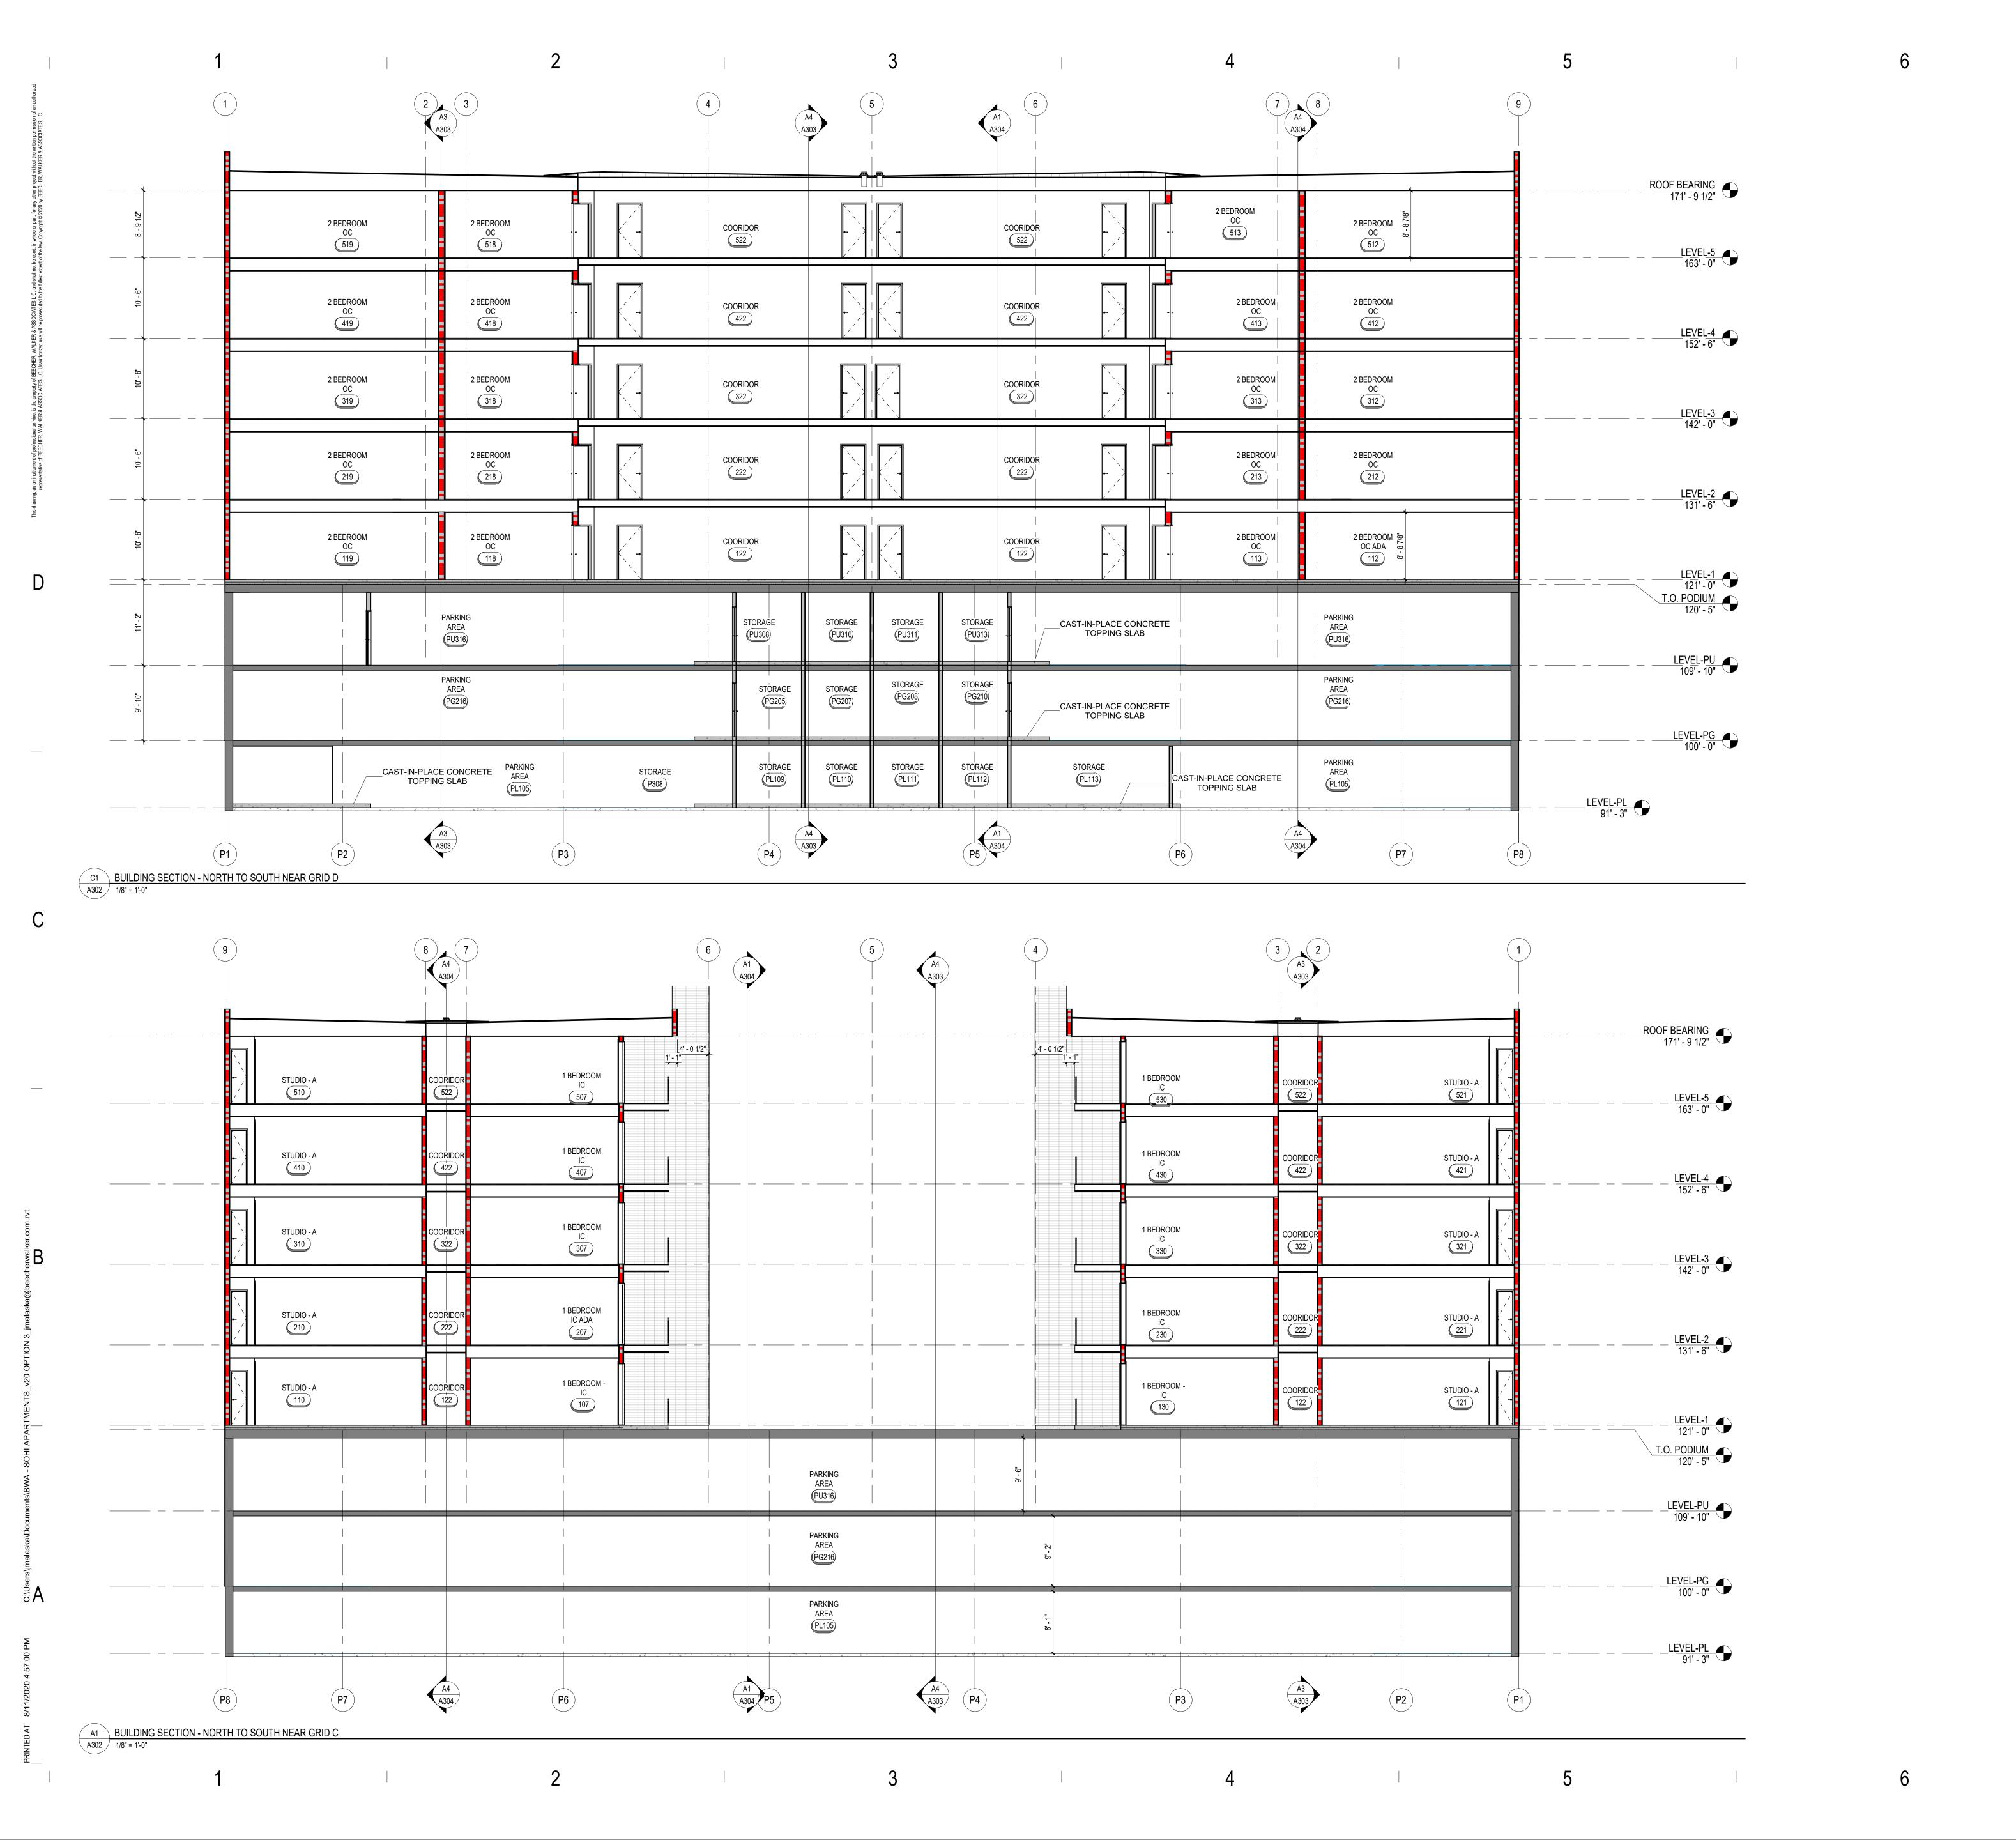

MARK ISSUE DESCRIPTION ISS. DATE # REV. DESCRIPTION REV. DATE
SD SCHEMATIC DESIGN 06.03.2020
2 SITE PLAN REVIEW 8-11-2020


D


SOHI APARMENTS
927 SOUTH 400 WEST
SALT LAKE CITY, UTAH 84101

and the control of th

BUILDING SECTIONS

A30

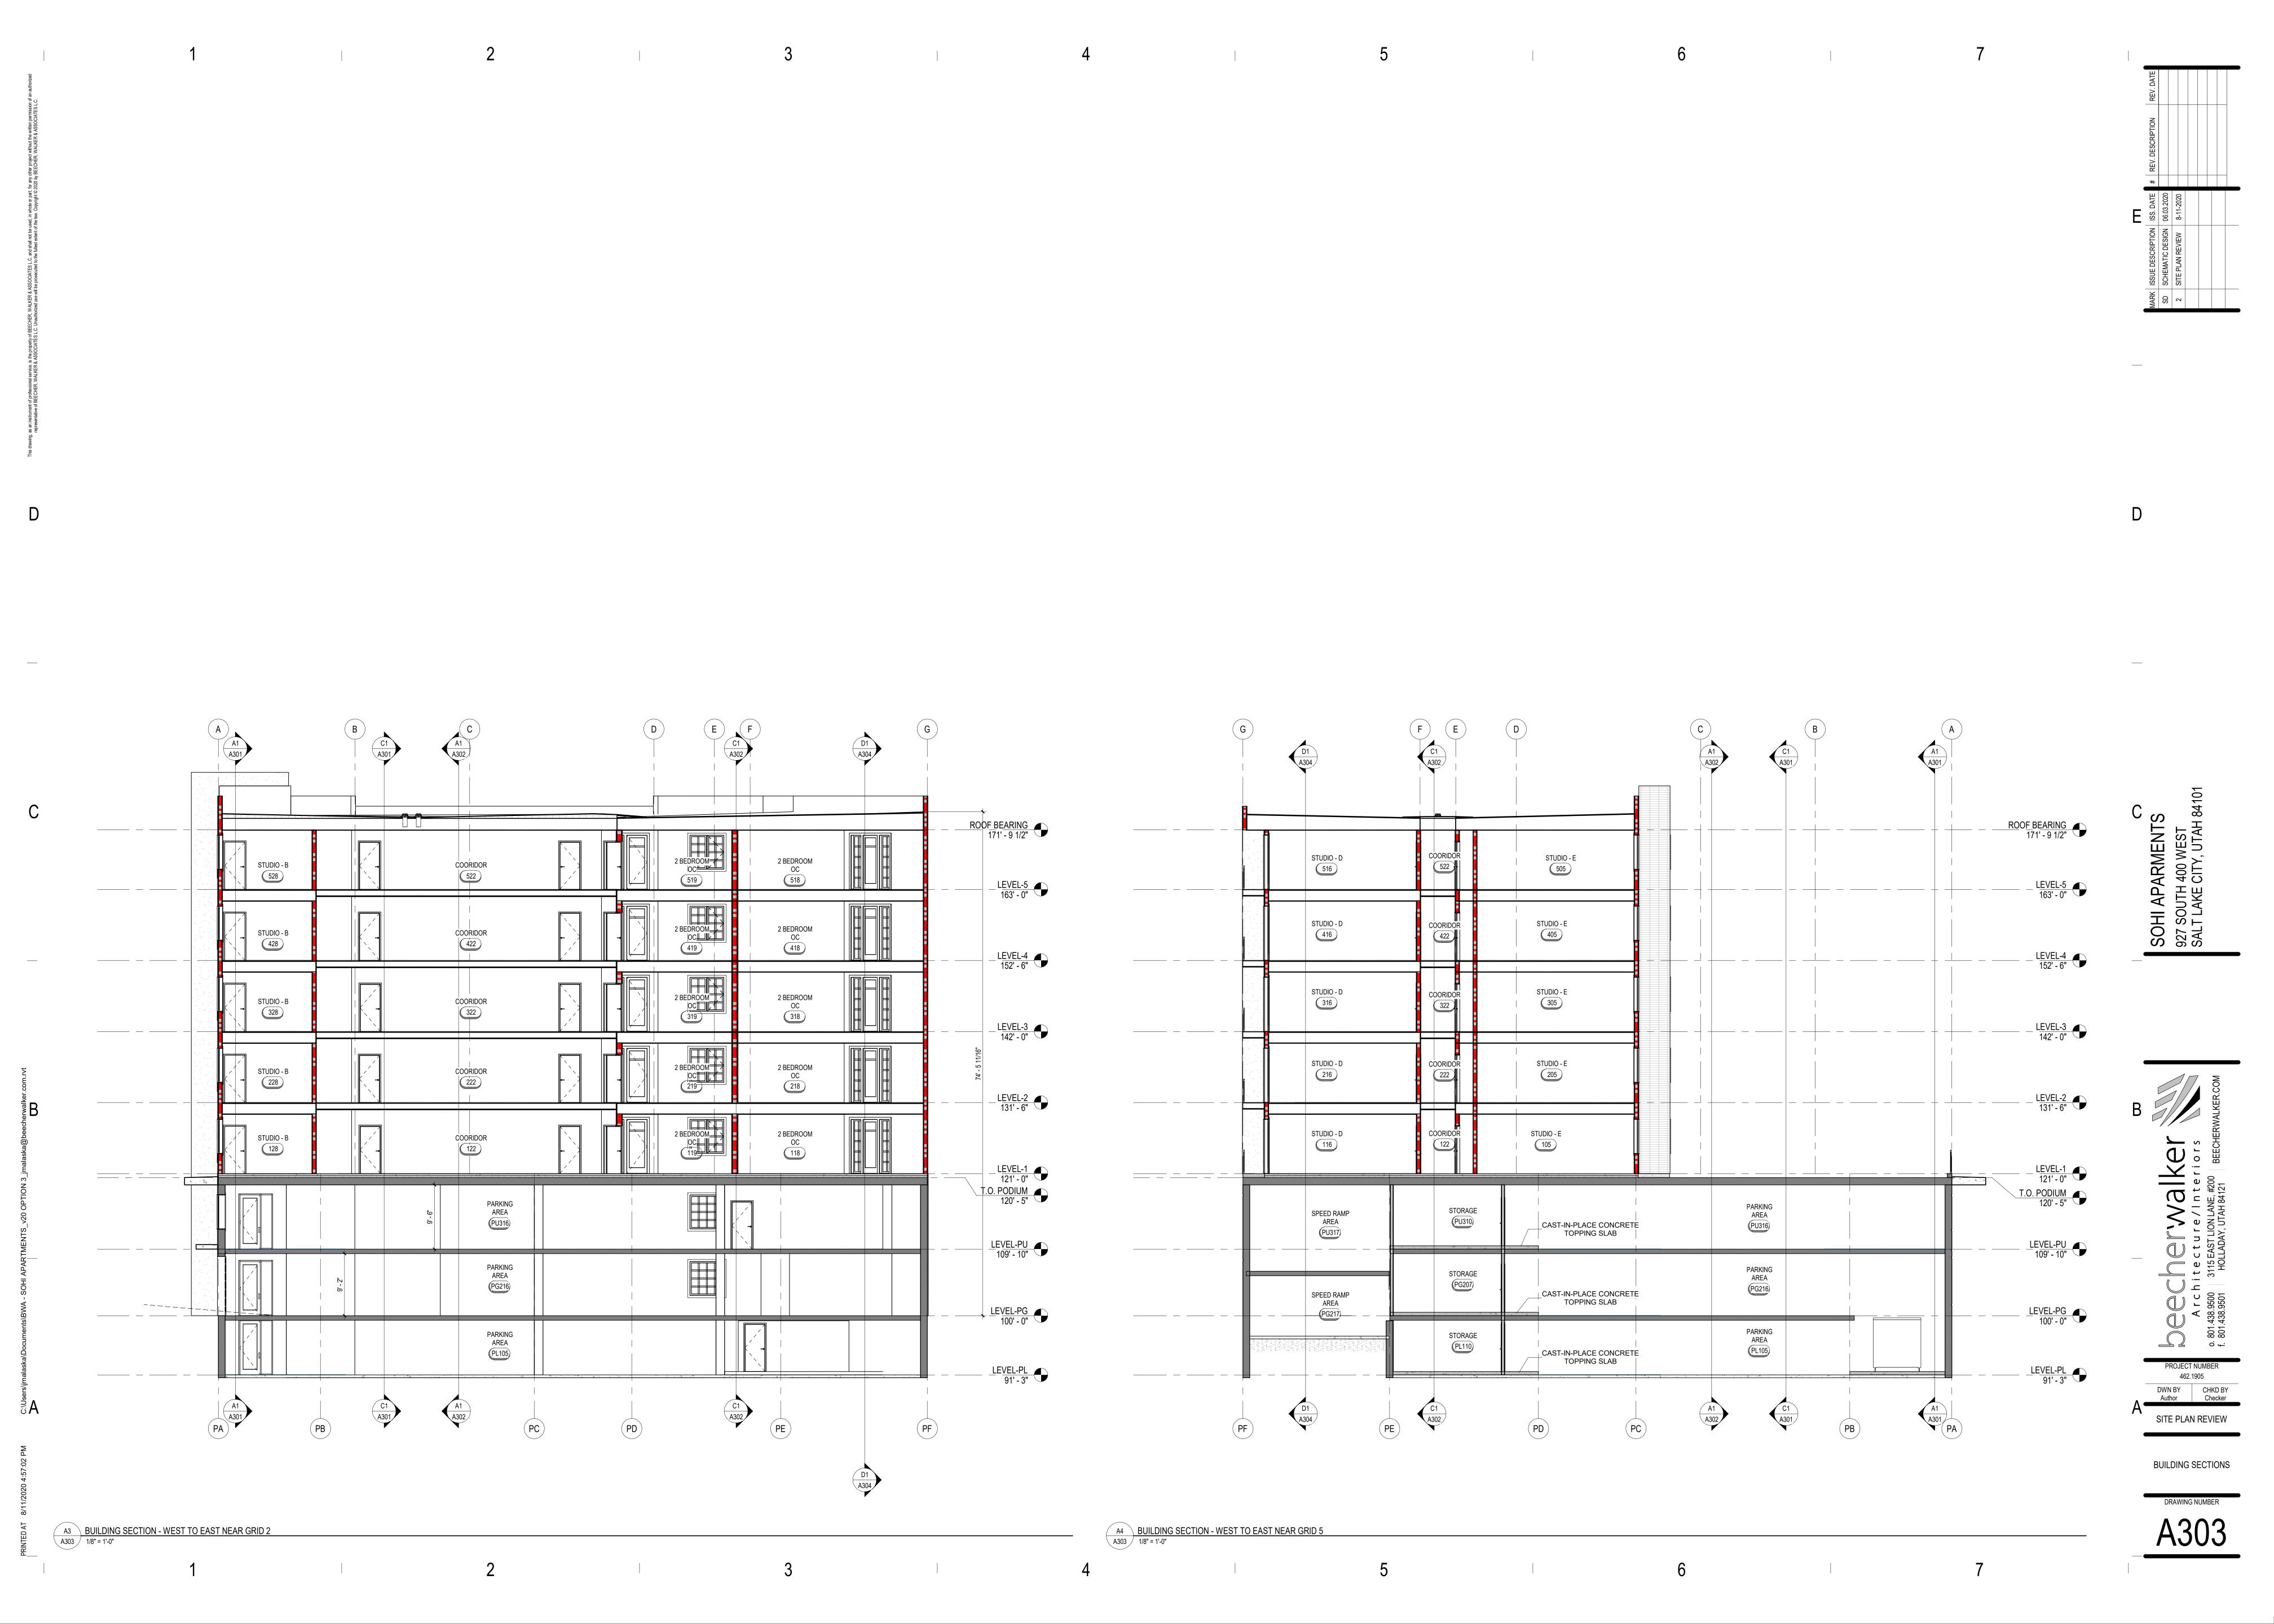

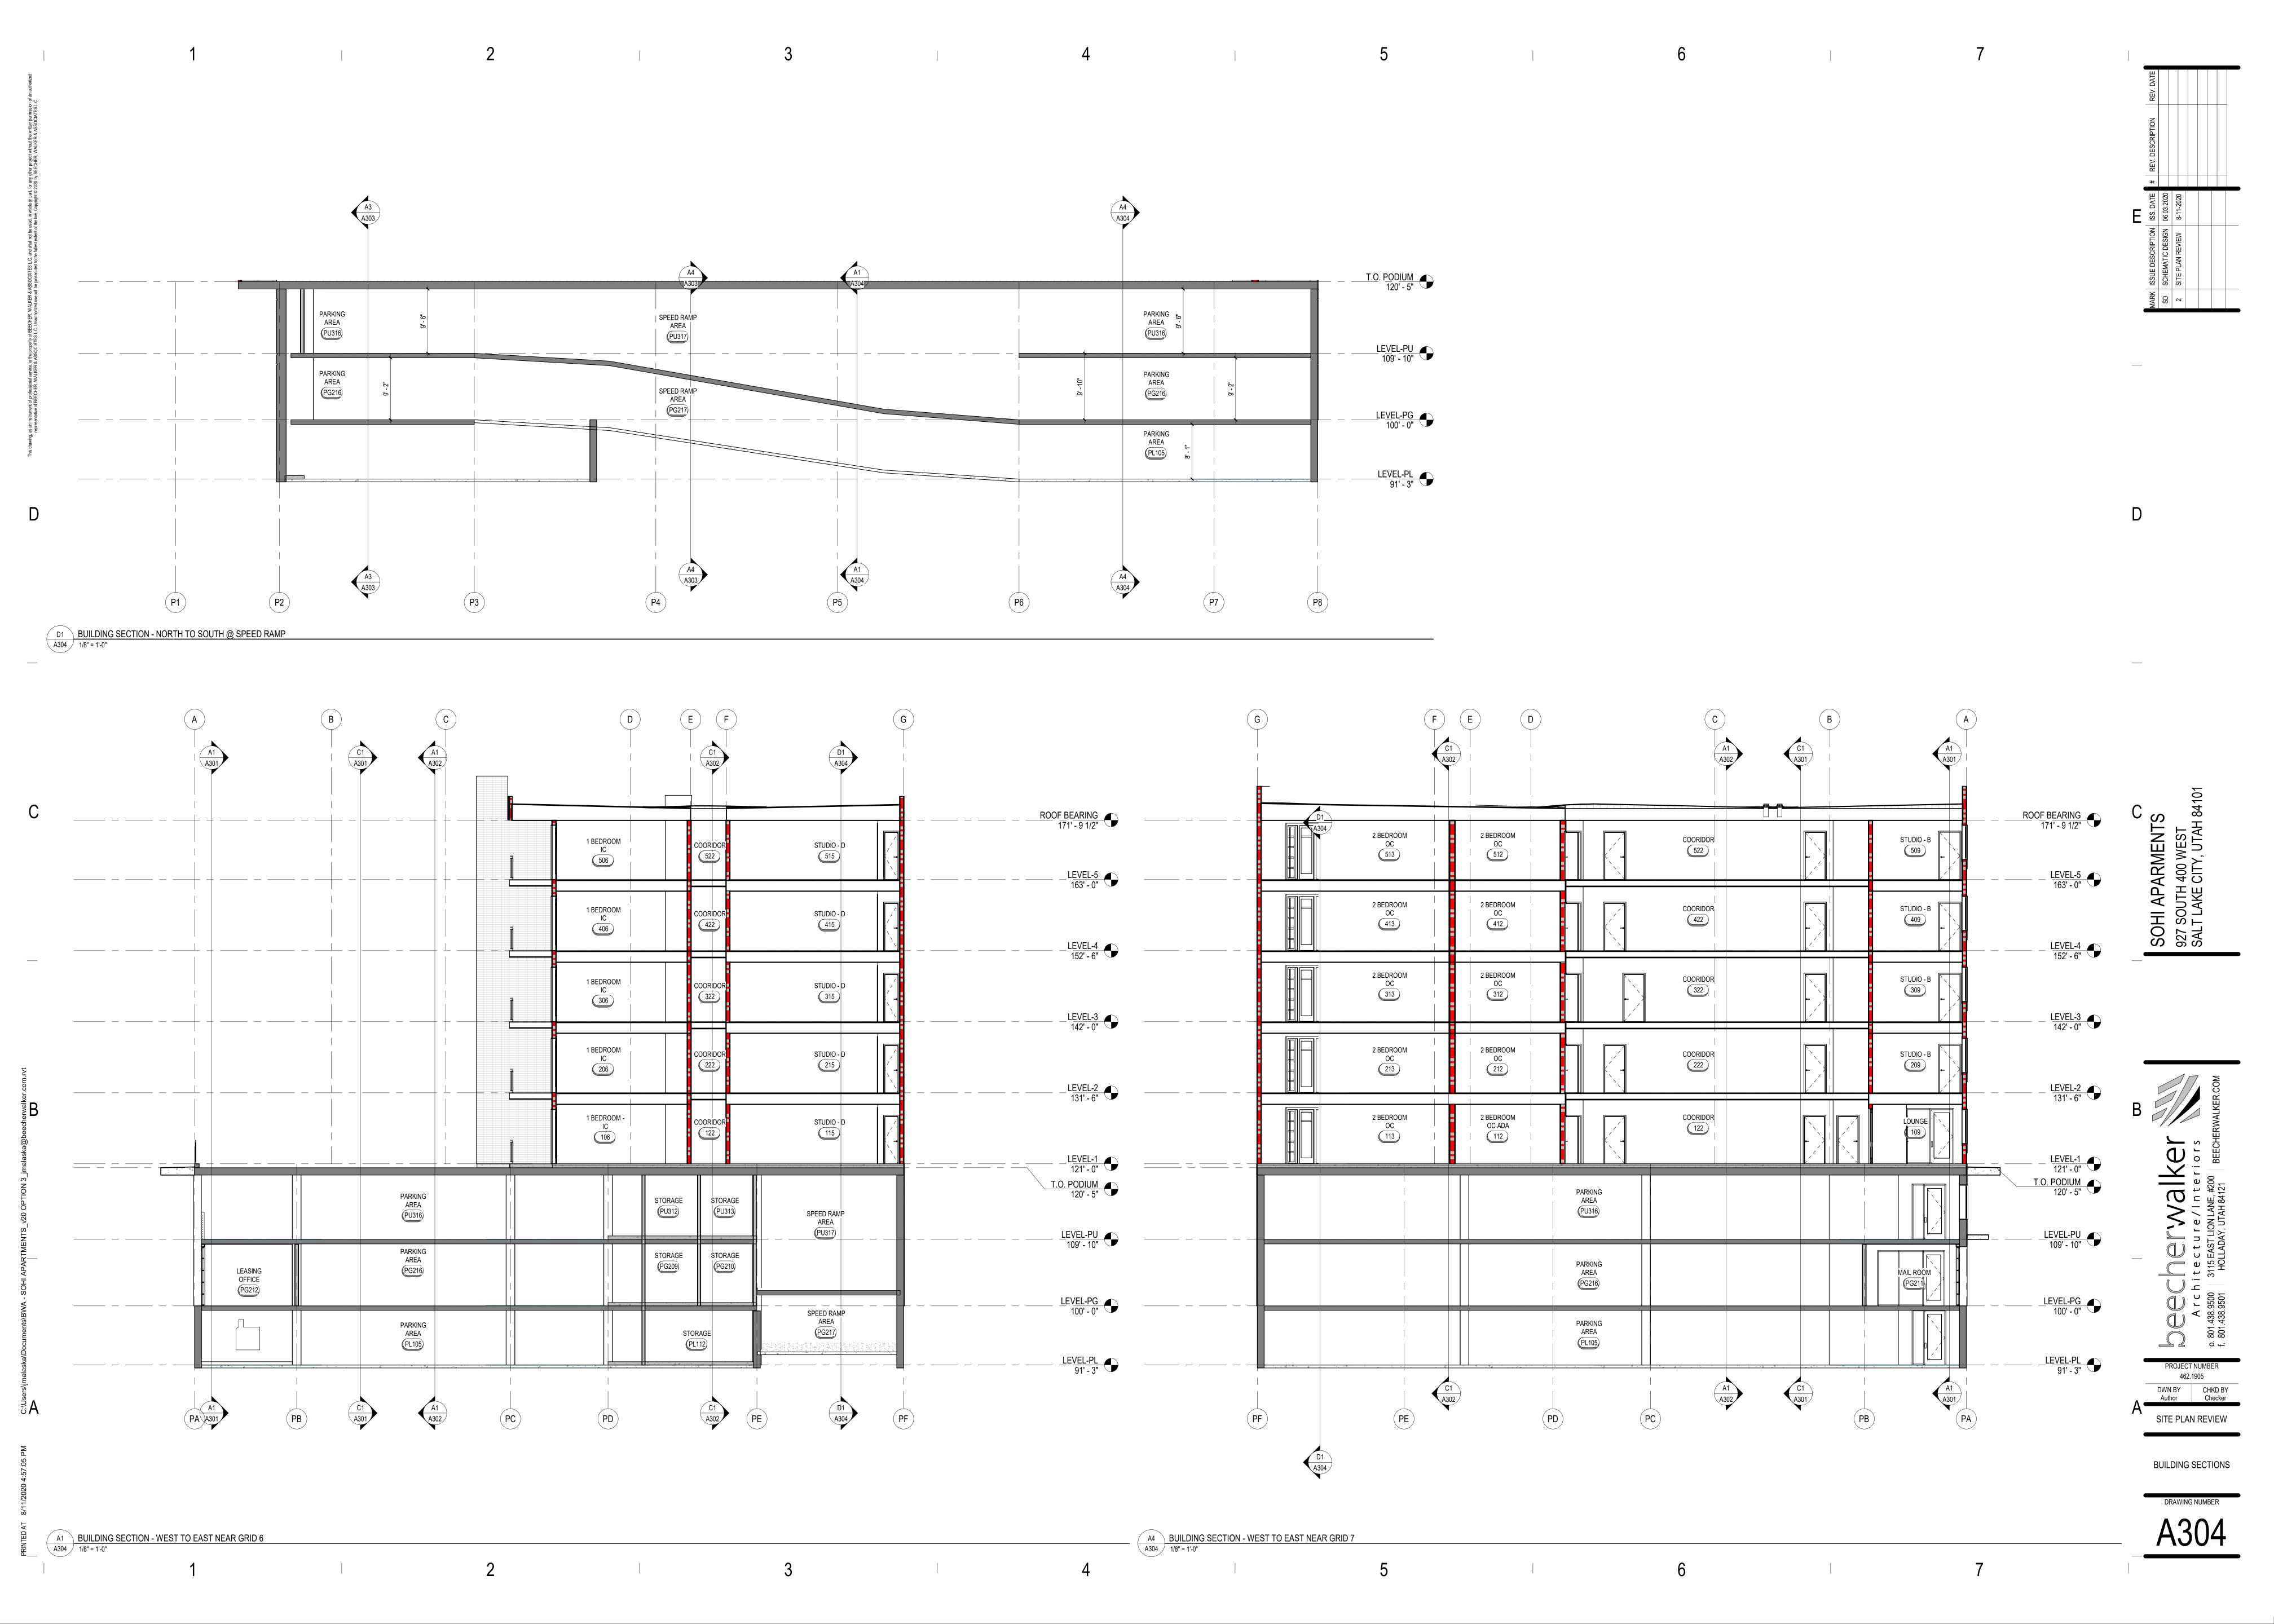



C4 PERSPECTIVE VIEW - SE CORNER
A901



A1 PERSPECTIVE VIEW - NW CORNER
A901



PERSPECTIVE VIEW - SW CORNER

SITE PLAN REVIEW

A901

PERSPECTIVE VIEWS